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	FLOOD HAZARD AREA AND IS LOCATED IN ZONE "X" (AREAS DETERMINED TO BE D) AS LOCATED ON THE ABOVE FEDERAL EMERGENCY MANAGEMENT AGENCY
	0108F, LAST REVISED JUNE 4, 2007; & 34031C0259F, LAST REVISED SEPTEMBER 28, 2007.
I FLOOD I	NSURANCE RATE MAP
	SCALE: 1"≈ 600'
	' V.
SHEET INDE	
1.0 COVER SHEET	
1.1 EXISTING CONDITIONS SIT	E PLAN
1.2 SITE DEMOLITION PLAN	
1.3 UTILITY DEMOLITION PLAN	N
2.0 LAYOUT PLAN	
3.0 GRADING AND DRAINAGE	PLAN
3.1 STORM DRAINAGE PROFIL	ES
4.0 UTILITY PLAN	
5.0 SOIL EROSION AND SEDIM	
5.1 SOIL EROSION AND SEDIM	
5.2 SOIL EROSION AND SEDIM	ENT CONTROL DETAILS
6.0 CONSTRUCTION DETAILS	
6.1 CONSTRUCTION DETAILS6.2 CONSTRUCTION DETAILS	
6.2 CONSTRUCTION DETAILS7.0 LIGHTING PLAN	
8.0 FIRE TRUCK CIRCULATION	ΡΙΔΝ
SUPPORT DOCUMENTATION:	
JULI OKI DOCUMENTATION.	

PRELIMINARY AND FINAL MAJOR SITE PLAN APPLICATION 111 IDEATION WAY PARKING LOT NUTLEY, NJ

111 IDEATION WAY TOWNSHIP OF NUTLEY, ESSEX COUNTY EXISTING BLOCK 300 - LOT 1 AND 1.05 PROPOSED LOT 1.05A

LIST OF VARIANCES) =) _

6.3.E.2.G - NUMBER OF PARKING SPACES REQUIRED 146 PROVIDED WHERE A MINIMUM OF 498 SPACES AND A MAXIMUM OF 830 SPACES ARE REQUIRED

OUTSIDE AGENCIES APPROVALS REQUIRED HUDSON ESSEX PASSAIC SOIL CONSERVATION DISTRIC

NUTLEY TREE REMOVAL

1.3 cvr.dwg
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1.0
201617110
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lot \
parking
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drawings
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civil
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TCI OF NORTHERN NEW JERSEY

NORFOLK SOUTHERN RAILWAY

SMITH JR. PUBLIC SAFETY BUILDING

ESSEX COUNTY UTILITIES AUTHORITY LEROY

NAME	ADDRESS		PROPERTY LOCATION	BLOCK-LOT	
PAIZIS, KALLERIS & HARITOMENI		E NUTLEY, NJ 07110	21 MONTCLAIR AVE	300-36	
O'BRIEN, MICHAEL & CHERYL		E NUTLEY, NJ 07110	36 MONTCLAIR AVE	300-12	
AUGUSTOWSKI, JOHN F. & LINDA		E NUTLEY, NJ 07110	62 MONTCLAIR AVE	300-19	
CANFIELD, ANDREW & HEATHER		E NUTLEY, NJ 07110	58 MONTCLAIR AVE	300-18	
SAUERS, RICK & DONNA		E NUTLEY, NJ 07110	25 MONTCLAIR AVE	300-35	
LOVERO, PATRICK J. & VERONDA E. HARRIS. MARGARET		E NUTLEY, NJ 07110 E NUTLEY, NJ 07110	38 MONTCLAIR AVE 54 MONTCLAIR AVE	300-13 300-17	
BELLINI, MICHAEL & ADRIENNE		E NUTLEY, NJ 07110	50 MONTCLAIR AVE	300-17	
PALMER, JAMES J. & MARIA		E NUTLEY, NJ 07110	27 MONTCLAIR AVE	300-34	
SANSONE, MICHAEL & TEELING C.	42 MONTCLAIR AV	E NUTLEY, NJ 07110	42 MONTCLAIR AVE	300-14	
MULLIGAN, ROBERT J. AND MARY G.		E NUTLEY, NJ 07110	31 MONTCLAIR AVE	300-33	
		E NUTLEY, NJ 07110		300-15	
DECOTIS, VICKI AND HUSSEY, KEVIN PAKHRIN, NGIMA T. & GURUNG, GANGA D		E NUTLEY, NJ 07110 E NUTLEY, NJ 07110	33 MONTCLAIR AVE 37 MONTCLAIR AVE	300-32 300-31	
SCHLESINGER, RICHARD & SANTA		E NUTLEY, NJ 07110	69 MONTCLAIR AVE	300-31	
BRUDER, ANN MARIE & JOESPEH & RENEE		E NUTLEY, NJ 07110	65 MONTCLAIR AVE	300-22	
SARNO, BRUCE AND DEBORAH	61 MONTCLAIR AVE	E NUTLEY, NJ 07110	61 MONTCLAIR AVE	300-23	
FRANSISCO, ANTHONY & LILA		E NUTLEY, NJ 07110	39 MONTCLAIR AVE	300-30	
YERO, JOEL & STEPHANIE		E NUTLEY, NJ 07110	59 MONTCLAIR AVE	300-24	
LU, XIAO JIA & WANG, PING		E NUTLEY, NJ 07110	55 MONTCLAIR AVE	300-25	
BUDNEY, SHARON LEE CARAMUCCI. GAETANO & LINDA		E NUTLEY, NJ 07110 E NUTLEY, NJ 07110	51 MONTCLAIR AVE 41 MONTCLAIR AVE	300-26 300-29	
BARRIENTOS, VICTOR & MARTHA		E NUTLEY, NJ 07110	21 CATHEDRAL AVE	300-23	
MERCADO, THERESA & ABNER		E NUTLEY, NJ 07110	49 MONTCLAIR AVE	300-27	
MURPHY, BRIAN J. CHRISTINA		E NUTLEY, NJ 07110	45 MONTCLAIR AVE	300-28	
SEGALL, PAUL & HILDEBRANT, MARIE	15 CATHEDRAL AV	E NUTLEY, NJ 07110	15 CATHEDRAL AVE	300-53	
ALGIERI, DEBRA		E NUTLEY NJ 07110	11 CATHEDRAL AVE	300-54	
MENDEZ, MILTON B. & CLAUDIA		NUTLEY, NJ 07110	278 KINGSLAND ST	300-58	
RUBIN, DAVID AND BERISH, BONNIE DUFFY, MICHAEL & MARY ANN		NUTLEY, NJ 07110 /E NUTLEY, NJ 0711	7 CATHEDRAL AVE 274 KINGSLAND ST	300-55 300-57	
FLIPING NUTLEY 1	52 ELM ST KEARNY		3 CATHEDRAL AVE	300-56	
PB NUTCLIF MASTER, LLC		DR BLOOMFIELD, NJ 07003	299 KINGSLAND ST	2101-1	
PB NUTCLIF MASTER, LLC	200 BROADACRES	DR BLOOMFIELD, NJ 07003	340 KINGSLAND ST	201-1	
RICOTTA, VINCENT JAMES		E NUTLEY, NJ 07110	12 MONTCLAIR AVE	300-4	
		E NUTLEY, NJ 07110	16 MONTCLAIR AVE	300-6	
	1 KENNEDY DR NU		750 BLOOMFIELD AVE 2 MONTCLAIR AVE	2100-8	
SUGRUE, SHAUN & LEILA COLON, RADHAMES	2 MONTCLAIR AVE 6 MONTCLAIR AVE		6 MONTCLAIR AVE	300-2 300-3	
MEECHAN, MICHAEL J.		E NUTLEY, NJ 07110	20 MONTCLAIR AVE	300-7	
LABATE, JOSEPH G.	5 MONTCLAIR AVE		5 MONTCLAIR AVE	300-41	
RAFANELLO, MARK AND BONNIE	22 MONTCLAIR AV	E NUTLEY, NJ 07110	22 MONTCLAIR AVE	300-8	
ALBANESE JOHN V. & JENNIFER L.	9 MONTCLAIR AVE		9 MONTCLAIR AVE	300-40	
BUCCA, MATTHEW A. & JENNIFER M.		E NUTLEY, NJ 07110	24 MONTCLAIR AVE	300-9	
PLINIO, THOMAS & LOIS JEAN PB NUTCLIF MASTER, LLC		E NUTLEY, NJ 07110 DR BLOOMFIELD, NJ 07003	11 MONTCLAIR AVE 66 MONTCLAIR AVE	300-39 300-20	
AQUINE, BELAZMIN		E NUTLEY, NJ 07110	15 MONTCLAIR AVE	300-20	
DALKILIC, ALI		E NUTLEY, NJ 07110	28 MONTCLAIR AVE	300-10	
PARK BROOK MANSIONS CONDOMINIUMS	800 BLOOMFIELD A	VE NUTLEY, NJ 07110	800 BLOOMFIELD AVE	2100-7	
YURCICH, CRAIG A. & MC ADAM, JENNIFER	17 MONTCLAIR AVE	E NUTLEY, NJ 07110	17 MONTCLAIR AVE	300-37	
ORLINSKI, LAURIE A. & THOMAS J.		E NUTLEY, NJ 07110	32 MONTCLAIR AVE	300-11	
PSEG SERVICES CORP/PROPERTIES DEPT		E NEWARK, NJ 07102	KINGSLAND STREET REAR	201-2	
NORFOLK SOUTHERN RAILROAD TGB INC.) JERSEY CITY, NJ 07307 AVE NUTLEY, NJ 07110	NEWARK BRANCH ROAD BLOOMFIELD AVE	10-2 2100-24	
MILLER, CONSTANCE R.		VE APT 20 NUTLEY, NJ 07110	800 BLOOMFIELD AVE C0201	2100-24 2100-9-C0201	
HOFFMAN - LA ROCHE INC.		VE #127 NUTLEY, NJ 07110	800 BLOOMFIELD AVE C0202	2100-9-C0202	
HOFFMAN - LA ROCHE INC.		AVE #127 NUTLEY, NJ 07110	800 BLOOMFIELD AVE C0203	2100-9-C0203	
HOFFMAN - LA ROCHE INC.		VE #127 NUTLEY, NJ 07110	800 BLOOMFIELD AVE C0204	2100-9-C0204	
SKOPINCEVA, JELENA		AVE APT 20 NUTLEY, NJ 07110	800 BLOOMFIELD AVE C0205	2100-9-C0205	
HANSULT, WILLIAM		VE APT 20 NUTLEY, NJ 07110	800 BLOOMFIELD AVE C0206	2100-9-C0206	
ACOMATA, EFRAIN & ZAMBRANA, PAMELA TOWNSHIP OF NUTLEY	14 MONTCLAIR AVE	E NUTLEY, NJ 07110	14 MONTCLAIR AVE KINGSLAND RD	300-5 2101-2	
PB NUTCLIF MASTER, LLC		DR BLOOMFIELD, NJ 07003	340 KINGSLAND RD	300-1	
		S TO BE NOTIFIED	340 KINGSLAND ST	300-1	
NAME		ADDRESS			
AT&T CORPORATE OFFICE			STER NI 07021 7207		
		P.O. BOX 7207 BEDMINSTER, NJ 07921-7207			
NJ DEPT. OF TRANSPORTATION		1035 PARKWAY AVE CN-600 TRENTON, NJ 08625 900 BLOOMFIELD AVE VERONA, NJ 07044			
ESSEX COUNTY PLANNING BOAR					
ESSEX COUNTY PLANNING BOAR WORKS BUILDING PSE&G COMPANY MANAGER COF		80 PARK PLAZA T6B NE	WARK, NJ 07102		
WORKS BUILDING PSE&G COMPANY MANAGER COF PROPERTIES	RPORATE				
WORKS BUILDING PSE&G COMPANY MANAGER COP PROPERTIES NORTH JERSEY DISTRICT WATER	RPORATE	1 F.A. ORECHIO DRIVE	WANAQUE, NJ 07465		
WORKS BUILDING PSE&G COMPANY MANAGER COF PROPERTIES	RPORATE	1 F.A. ORECHIO DRIVE 1525 MAIN AVENUE CLI	WANAQUE, NJ 07465	404	

40 POTATO ROAD OAKLAND, NJ 07436 ATTN: DAN GANNON

60 NELSON PLACE 6TH FLOOR NEWARK, NJ 07102

125 COUNTY ROAD JERSEY CITY, NJ 07307

EXISTING CONDITIONS TOPOGRAPHIC SURVEY

PROPOSED LANDSCAPING PLANS AND DETAILS



APPLICANT: PB NUTCLIF MASTER, LLC 200 Metro Boulevard - Suite 1300 Nutley, NJ 07110 C/O Meryl A. G. Gonchar, Esq. (609) 227-4639

ENGINEER: GreenbergFarrow

J
CONTACT: STEPHEN POWERS, PE
2 EAST MAIN STREET, SUITE 410
SOMERVILLE, NJ 08876
(908) 300-5576

THE PROVISIONS SET FORTH IN THIS REDEVELOPMENT PLAN SHALL SUPERSEDE GOVERN AND CONTROL THE EQUIVALENT STANDARDS SET FORTH IN THE ZONING (CHAPTER 700) AND SITE PLAN REVIEW (CHAPTER 600) CHAPTERS OF THE TOWNSHIP OF NUTLEY MUNICIPAL CODE. ANY STANDARD, DEFINITION OR REGULATION IN THE TOWNSHIP OF NUTLEY.

ZONING DESIGI NUTLEY ZONIN RRP-2A ROCH PHASE

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MAXIMU MINIMU *COVER (E) = EXI NOTES:

2. R 3. E PARKI TOTAL

<u>PROPOSED</u>

27,643 SF

1,683 SF

<u>65,442 SF</u>

94,768 SF

IMPERVIOUS SITE AREA TABLE

PAVEMENT & WALKWAY AREA 56,795 SF

TOWNSHIP OF NUTLEY:

TOTAL IMPERVIOUS AREA

<u>LOT 1.05:</u> BUILDING AREA

SKY WALK AREA

<u>EXISTING</u>

27,643 SF

1,683 SF

86,121 SF

SURVEYOR:

KELLER & KIRKPATRICK INC

301 GIBRALTAR DRIVE, SUITE 2A

MORRIS PLAINS, NJ 07950

PHONE: (973) 377-8500 PROJ: 2016072

GREENBERGFARROW

ATLANTA, GA 30309

PHONE: (404) 601-4000

LANDSCAPE ARCHITECT **IDEATION** EXISTI PROPO 1430 WEST PEACHTREE STREET, NW, SUITE 200

NET INCREASE OF 3 PARKING SPACES OVERALL NET INCREASE OF 29 PARKING SPACES

B-D	PD-	HC	B	AC
	ATE HIGHWAY ROL			
	CALE: 1" = 500'			
ZONING: ROCHE REDEVELOPMENT PHASE IIA	IOFFMAN LA-ROCHE EDEVELOPMENT AREA WITH ITY OF CLIFTON IOFFMAN LA-ROCHE EDEVELOPMENT AREA WITH ITY OF CLIFTON HASE 2B		HOFFMAN LA-ROCHE REDEVELOPMENT AREA V TOWNSHIP OF NUTLEY HOFFMAN LA-ROCHE REDEVELOPMENT AREA V TOWNSHIP OF NUTLEY PHASE 1 HOFFMAN LA-ROCHE REDEVELOPMENT AREA V TOWNSHIP OF NUTLEY	WITHIN
ALL LEASE AREAS REFERENCED IN THIS PLAN AREA AND BULK REQU PROPOSED ZONING DISTRICT: RRP-2A ROCHE R <u>ITEM DESCRIPTIONS</u>	REMENTS :		PHASE 2A MENT AREA PROPOSED LOT 1.05A	
MINIMUM LOT AREA (SQUARE FEET)	43,560 SF (1.00 AC)	178,319 SF (4.09 AC)	52,272 SF (1.20 AC)	
	120'	411' 25 <i>4</i> '	171' 	
MINIMUM LOT DEPTH (FEET) MINIMUM FRONT YARD BUILDING SETBACK (FEET)	150' 0'	354' 2.9'	201' N/A	
MINIMUM SIDE YARD (ONE SIDE) BUILDING SETBACK (FEE		2. 3 167.9'	N/A	
MINIMUM SIDE YARD (OTHER SIDE) BUILDING SETBACK (F	,	46.2'	N/A	
MINIMUM REAR YARD BUILDING SETBACK (FEET)	40'	121.2'	N/A	
MINIMUM LANDSCAPE BUFFER ADJACENT TO RESIDENTIAL USES (FEET)	17.75'	20.2'	N/A	
MAXIMUM BUILDING HEIGHT (FEET)	EX. BLDG. HEIGHT/110'	6 STORIES/103'	N/A	
MAXIMUM BUILDING COVERAGE (%)	30%	15.5% SKY WALK 0.9%	0.2%	
MAXIMUM IMPERVIOUS COVERAGE (%)	75%	53.15%*	4.5%	
MINIMUM PARKING SPACES	SEE CALC BELOW	146 SPACES (E)	N/A	
 *COVERAGE CALCULATION INCLUDES AREA OF 111 IDEAT (E) = EXISTING NON-CONFORMITY NOTES: PROPOSED REQUIREMENTS ARE BASED ON THE R DATED JULY 17, 2018 AS PREPARED BY TOPOLOGY REFER TO IMPERVIOUS SITE AREA TABLE BELOW F EXISTING BOUNDARY INFORMATION IS BASED OFF 300 ENTITLED, " PRELIMINARY & FINAL MAJOR SUB DECEMBER 20, 2018 AS PREPARED BY PS&S. THE I PARKING SPACE CALCULATIONS: TOTAL REQUIRED PARKING SPACES** 	EDEVELOPMENT PLAN ENTITI FOR EXISTING AND PROPOSEI PREVIOUSLY APPROVED SUE DIVISION, TOWNSHIP OF NUTL	LED "NUTLEY PHASE IIA I D IMPERVIOUS AREA BRI BDIVISION PREPARED FC LEY, ESSEX COUNTY NEV	REDEVELOPMENT PLAN" EAKDOWN CALCULATIONS DR LOTS 1.05 & 1.06, BLOCK W JERSEY" DATED	
MIN - OFFICE FOOTPRINT X 3.0 SPACES/1,000 SF + MEDIC = (27,643 SF X 3 SPACES/1,000 SF) + (138,215 SF X 3 = 83 SPACES + 415 SPACES = 498 SPACES MAX - OFFICE FOOTPRINT X 5.0 SPACES/1,000 SF + MEDI = (27,643 SE X 5 SPACES/1,000 SE) + (138,215 SE X 5	SPACES/1,000 SF) CAL RESEARCH FOOTPRINT X			
= (27,643 SF X 5 SPACES/1,000 SF) + (138,215 SF X 5 = 139 SPACES + 691 SPACES = 830 SPACES TOTAL BROVIDED BARKING SPACES - 146 SPACES (INCL				
TOTAL PROVIDED PARKING SPACES = 146 SPACES (INCL ** FLOOR AREA DISTRIBUTIONS TO BE CONFIRMED BY THE APPLICANT			(KING SPACES)	
PARKING CALCULATION		Approved by Pl		
EXISTING PARKING SPACES	120 STALLS	Township of Nu		
PROPOSED STANDARD PARKING SPACES PROPOSED PARALLEL PARKING SPACES PROPOSED ADA STANDARD ACCESSIBLE PARKING SPACES PROPOSED ADA VAN ACCESSIBLE PARKING SPACES	135 STALLS 6 STALLS 4 STALLS 1 STALLS	Planning Board Planning Board		Date Date
PROPOSED ADA VAN ACCESSIBLE PARKING SPACES TOTAL PROPOSED PARKING SPACES NET INCREASE OF <u>26</u> PARKING SPACES	<u>1 STALLS</u> 146 STALLS	Township Engin		Date
IDEATION WAY STREET PARKING		[
EXISTING PARALLEL PARKING SPACES PROPOSED ANGLED PARKING SPACES	7 STALLS 10 STALLS	Approved by th County of Esse	ne County Planning Board ex New Jersey	

Planning Board Chairperson

GreenbergFarrov

92 East Main Street, Suite 410 Somerville, NJ 08876 : 732-537-0811





PROFESSIONAL SEAL



PROFESSIONAL IN CHARGE **STEPHEN POWERS** PROFESSIONAL ENGINEER LICENSE NO. 24GE04773100 **PROJECT MANAGER** RICHARD PROCANIK **QUALITY CONTROL** RICHARD PROCANIK DRAWN BY

THOMAS WIENCKOWSKI **PROJECT NAME**

111 IDEATION WAY PARKING LOT

NUTLEY NEW JERSEY

EXISTING BLOCK 300 LOT 1 & 1.05 PROPOSED LOT 1.05A TOWNSHIP OF NUTLEY ESSEX COUNTY, NJ ZONING DISTRICT: RRP-2A ROCHE REDEVELOPMENT PLAN PHASE IIA

PROJECT NUMBER 20161711

SHEET TITLE

COVER SHEET



Date

DEATION WAYNG PARKING SPACES120STALLSNSED STANDARD PARKING SPACES135STALLSSED PARALLEL PARKING SPACES6STALLSSED ADA STANDARD ACCESSIBLE PARKING SPACES4STALLSPROPOSED PARKING SPACES1STALLSPROPOSED PARKING SPACES146STALLSICREASE OF 26 PARKING SPACES146STALLSON WAY STREET PARKINGSPACES7STALLSNG PARALLEL PARKING SPACES10STALLS				
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DN WAY STREET PARKING NG PARALLEL PARKING SPACES 7 STALLS	SED PARALLEL PARKING SPACES SED ADA STANDARD ACCESSIBLE PARKING SPACES SED ADA VAN ACCESSIBLE PARKING SPACES	6 4 1	STALLS STALLS STALLS	
NG PARALLEL PARKING SPACES 7 STALLS	—			
	<u>ON WAY STREET PARKING</u>			
		-		



The second secon	400' PROPERTY UNE OFFSET
400' PROF	PERTY LINE OFFSET (2)
SCALE: 1"=200'	1.1
	PROJECT PROPERTY BOUNDARY LINE ESSEX COUNTY/PASSAIC COUNTY BOUNDARY LINE ADJACENT PROPERTY LINE SETBACK LINE EASEMENT LINE EXISTING CURB EXISTING EDGE OF PAVEMENT EXISTING EDGE OF CONCRETE EXISTING GUIDERAIL EXISTING FENCE EXISTING TREE LINE EXISTING TREE LINE EXISTING STORM INLET EXISTING STORM INLET EXISTING STORM MANHOLE EXISTING STORM MANHOLE EXISTING STORM TINE EXISTING STORM FIXTURE
KINGSLAND STREET" 02/06/2017. 2. ROADWAY IMPROVEME FOR SETON HALL-HA PREPARED BY GREEN 05/04/2018. 3. EXISTING BOUNDARY APPROVED SUBDIVISIO 300 ENTITLED, "PREL OF NUTLEY, ESSEX O AS PREPARED BY PS	C SURVEY BASED ON PLAN ENTITLED "340 PREPARED BY KELLER & KIRKPATRICK INC., DATED NTS BASED ON PLAN ENTITLED "ROADWAY DESIGN CKENSACK MERIDIAN SCHOOL OF MEDICINE", BERGFARROW, DATED 01/03/2017, LAST REVISED NFORMATION IS BASED OFF PREVIOUSLY IN PREPARED FOR LOTS 1.05 & 1.06, BLOCK MINARY & FINAL MAJOR SUBDIVISION, TOWNSHIP OUNTY NEW JERSEY" DATED DECEMBER 20, 2018 &S. THE PLAT WAS RECORDED ON DECEMBER NTIFIED AS MAP #4711.

GreenbergFarrow COA#: GA28079

92 East Main Street, Suite 410 Somerville, NJ 08876 t: 732-537-0811

referenced for any p project and be reprodu	COPYRIGHT ng is the pr Professional c urpose othe d site namec uced in any ten permission	operty o and is no r than d herein, manner	ot to be used the specific and canno ^t without the
ISSUE/F	REVISION	I REC	ORD
DATE	DESCRIPTI	ЛС	
07/07/202	20 BID SET 20 Planning	BOARD	SUBMISSION
PROFES	SSIONAL	SEAL	



PROFESSIONAL IN CHARGE STEPHEN POWERS PROFESSIONAL ENGINEER LICENSE NO. 24GE04773100

PROJECT MANAGER RICHARD PROCANIK **QUALITY CONTROL** RICHARD PROCANIK

DRAWN BY THOMAS WIENCKOWSKI

PROJECT NAME

111 IDEATION WAY PARKING LOT

NUTLEY **NEW JERSEY**

EXISTING BLOCK 300 LOT 1 & 1.05 PROPOSED LOT 1.05A TOWNSHIP OF NUTLEY ESSEX COUNTY, NJ ZONING DISTRICT: RRP-2A ROCHE REDEVELOPMENT PLAN PHASE IIA

PROJECT NUMBER 20161711.0

SHEET TITLE

EXISTING CONDITIONS

SITE PLAN

SHEET NUMBER

GRAPHIC SCALE

(IN FEET) 1 inch = 50 ft.




- - PAVEMENT SAWCUT LINE X X EXISTING FENCE TO REMAIN -x -x EXISTING FENCE TO BE REMOVED EXISTING CONCRETE TO BE REMOVED SITE DEMOLITION NOTES

- BODY'S STANDARDS.

- ON SITE.

- 2 REMOVE EXISTING ASPHALT PAVEMENT.
- 3 REMOVE EXISTING CONCRETE PAVEMENT.
- 4 REMOVE EXISTING CURB.
- (TOTAL 18 TREES TO BE REMOVED)
- 6 REMOVE EXISTING FENCE 7 RELOCATE EXISTING LIGHT FIXTURE
- 8 REMOVE EXISTING SIGN

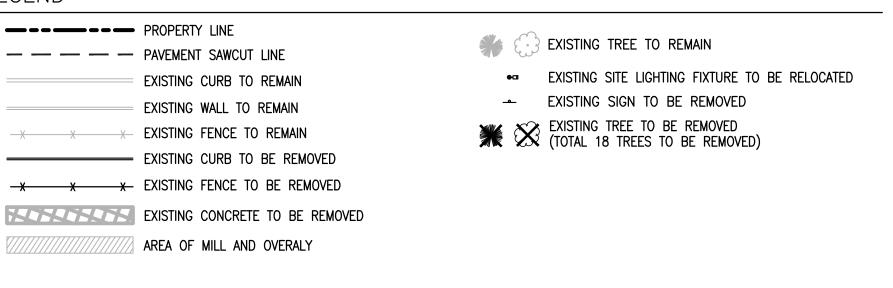

1. ANY DEMOLITION IS TO BE PERFORMED IN STRICT CONFORMANCE WITH ALL APPLICABLE CITY, COUNTY AND STATE, AND/OR GOVERNING

THE DEMOLITION PLAN SHALL BE DONE IN CONJUNCTION WITH THE GEOTECHNICAL INVESTIGATION REPORT

EROSION AND SEDIMENT CONTROL MEASURES SHALL BE MAINTAINED AT ALL TIMES DURING DEMOLITION. 4. THE PURPOSE OF THIS DRAWING IS TO CONVEY THE OVERALL SCOPE OF WORK AND IT IS NOT INTENDED TO COVER ALL DETAILS OR SPECIFICATIONS REQUIRED TO COMPLY WITH GENERALLY ACCEPTED DEMOLITION PRACTICES. CONTRACTOR SHALL THOROUGHLY FAMILIARIZE HIMSELF WITH THE SITE, SCOPE OF WORK, AND ALL EXISTING CONDITIONS AT THE JOB SITE PRIOR TO BIDDING AND COMMENCING THE WORK. THE DEMOLITION CONTRACTOR SHALL BE SOLELY RESPONSIBLE FOR MEANS, METHODS, TECHNIQUES, OR PROCEDURES USED TO COMPLETE THE WORK IN ACCORDANCE WITH THE CONSTRUCTION DOCUMENTS AND IS LIABLE FOR THE SAFETY OF THE PUBLIC OR CONTRACTOR'S EMPLOYEES DURING THE COURSE OF THE PROJECT.

5. THE DEMOLITION PLAN IS INTENDED TO SHOW REMOVAL OF KNOWN SITE FEATURES AND UTILITIES AS SHOWN ON THE SURVEY. THERE MAY BE OTHER SITE FEATURES, UTILITIES, STRUCTURES, AND MISCELLANEOUS ITEMS BOTH BURIED AND ABOVE GROUND THAT ARE WITHIN THE LIMITS OF WORK THAT MAY NEED TO BE REMOVED FOR THE PROPOSED PROJECT THAT ARE NOT SHOWN HEREON. THE CONTRACTOR IS RESPONSIBLE FOR THE REMOVAL OF SUCH ITEMS AT NO ADDITIONAL COST TO THE OWNER.

6. THE CONTRACTOR SHALL CONTACT RESPECTIVE UTILITY COMPANIES PRIOR TO DEMOLITION TO COORDINATE DISCONNECTION AND REMOVAL OF EXISTING UTILITIES WITHIN THE AREA OF WORK. 7. THE CONTRACTOR SHALL BE SOLELY RESPONSIBLE FOR ANY DAMAGE TO EXISTING UTILITIES THAT ARE INTENDED TO CONTINUE TO

PROVIDE SERVICE WHETHER THESE UTILITIES ARE SHOWN ON THE PLAN OR NOT. B. UPON DISCOVERY OF ANY UNDERGROUND TANKS, CONTRACTOR SHALL IMMEDIATELY NOTIFY THE OWNER'S REPRESENTATIVE. NO REMOVAL OF TANKS SHALL OCCUR UNTIL AUTHORIZED BY OWNER.

9. BUILDING AND APPURTENANCES DESIGNATED FOR DEMOLITION SHALL NOT BE DISTURBED BY THE CONTRACTOR UNTIL HE HAS BEEN FURNISHED WITH NOTICE TO PROCEED BY THE OWNERS. AS SOON AS SUCH NOTICE HAS BEEN GIVEN, THE CONTRACTOR SHALL PERFORM THE DEMOLITION, UNDER THE DIRECTION OF THE OWNER'S REPRESENTATIVE.

10. DEBRIS SHALL NOT BE BURIED ON THE SUBJECT SITE. ALL UNSUITABLE MATERIAL AND DEBRIS SHALL BE REMOVED FROM THE SITE AND DISPOSAL IN ACCORDANCE WITH ALL CITY, STATE, AND FEDERAL LAWS AND ORDINANCES. 11. ALL MATERIAL, EXCEPT THAT BELONGING TO A PUBLIC UTILITY COMPANY OR DENOTED FOR SALVAGE, SHALL BECOME PROPERTY OF THE

CONTRACTOR. THE CONTRACTOR SHALL NOTIFY THE OWNER OF WATER, ELECTRIC, OR GAS METER WHEN THE METERS ARE READY FOR REMOVAL, AND THE CONTRACTOR SHALL BE RESPONSIBLE FOR DISCONNECTING ALL UTILITIES IN COMPLIANCE WITH LOCAL REQUIREMENTS. DISCONNECT TRANSFORMERS AS REQUIRED FOR BUILDING DEMOLITIONS. 12. AS SOON AS DEMOLITION WORK HAS BEEN COMPLETED, THE FINAL GRADE OF BACKFILL IN DEMOLITION AREAS SHALL BE COMPACTED

PER THE GEOTECHNICAL REPORT TO PRESENT A NEAT, WELL DRAINED APPEARANCE, AND TO PREVENT WATER FROM DRAINING UNNECESSARILY ONTO ADJACENT PROPERTIES. CONTRACTOR SHALL GRADE SITE TOWARD EXISTING STORM DRAINAGE SYSTEM TO REMAIN

13. EXISTING TREES TO REMAIN SHOULD BE PROTECTED FROM DAMAGE DURING DEMOLITION AND CONSTRUCTION. 14. THE CONTRACTOR IS TO COORDINATE WORK IN THE PROJECT TO ENSURE ACCESS TO ADJACENT PROPERTIES AT ALL TIMES. 15. THE USE OF EXPLOSIVES SHALL NOT BE PERMITTED. 16. CONTRACTOR TO IMPLEMENT APPROPRIATE TRAFFIC CONTROL MEASURES PER LOCAL CODE.


SITE DEMOLITION KEY NOTES

REFERENCES

- 1 SAWCUT EXISTING ASPHALT AND/OR CONCRETE PAVEMENT.
- 2A MILL AND OVERLAY EXISTING ASPHALT PAVEMENT.
- 5 REMOVE OR TRIM EXISTING TREE AND VEGETATED AREAS.

- EXISTING TOPOGRAPHIC SURVEY BASED ON PLAN ENTITLED "340 KINGSLAND STREET" PREPARED BY KELLER & KIRKPATRICK INC., DATED 02/06/2017.
- 2. ROADWAY IMPROVEMENTS BASED ON PLAN ENTITLED "ROADWAY DESIGN FOR SETON HALL-HACKENSACK MERIDIAN SCHOOL OF MEDICINE", PREPARED BY GREENBERGFARROW, DATED 01/03/2017, LAST REVISED 05/04/2018.
- 3. EXÍSTING BOUNDARY INFORMATION IS BASED OFF PREVIOUSLY APPROVED SUBDIVISION PREPARED FOR LOTS 1.05 & 1.06, BLOCK 300 ENTITLED, "PRELIMINARY & FINAL MAJOR SUBDIVISION, TOWNSHIP OF NUTLEY, ESSEX COUNTY NEW JERSEY" DATED DECEMBER 20, 2018 AS PREPARED BY PS&S. THE PLAT WAS RECORDED ON DECEMBER 18, 2019 AND IS IDENTIFIED AS MAP #4711.

TREE REMOVAL	WITHIN BLOCK 3	00 – LOT 1.05
QUANTITY	SPECIES	SIZE
1	HEMLOCK	7"
1	HOLLY	6"
1	HOLLY	7"
1	MAPLE	6"
1	OAK	21"
1	OAK	24"
1	OAK	28"
1	OAK	29"
1	OAK	30"
1	PEAR	13"
2	PINE	6"
1	PINE	7"
3	PINE	8"
1	PINE	10"
1	TWIN-PINE	6"

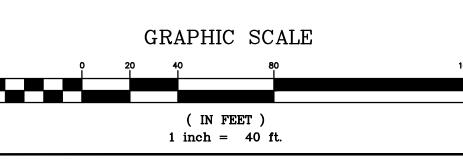

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PROFESSIONAL IN CHARGE **STEPHEN POWERS** PROFESSIONAL ENGINEER LICENSE NO. 24GE04773100 PROJECT MANAGER RICHARD PROCANIK QUALITY CONTROL RICHARD PROCANIK DRAWN BY

THOMAS WIENCKOWSKI PROJECT NAME

111 IDEATION WAY PARKING LOT

NUTLEY **NEW JERSEY**

EXISTING BLOCK 300 LOT 1 & 1.05 PROPOSED LOT 1.05A TOWNSHIP OF NUTLEY ESSEX COUNTY, NJ ZONING DISTRICT: RRP-2A ROCHE REDEVELOPMENT PLAN PHASE IIA


PROJECT NUMBER 20161711.0

SHEET TITLE

SITE DEMOLITION PLAN

SHEET NUMBER

Ι.Ζ

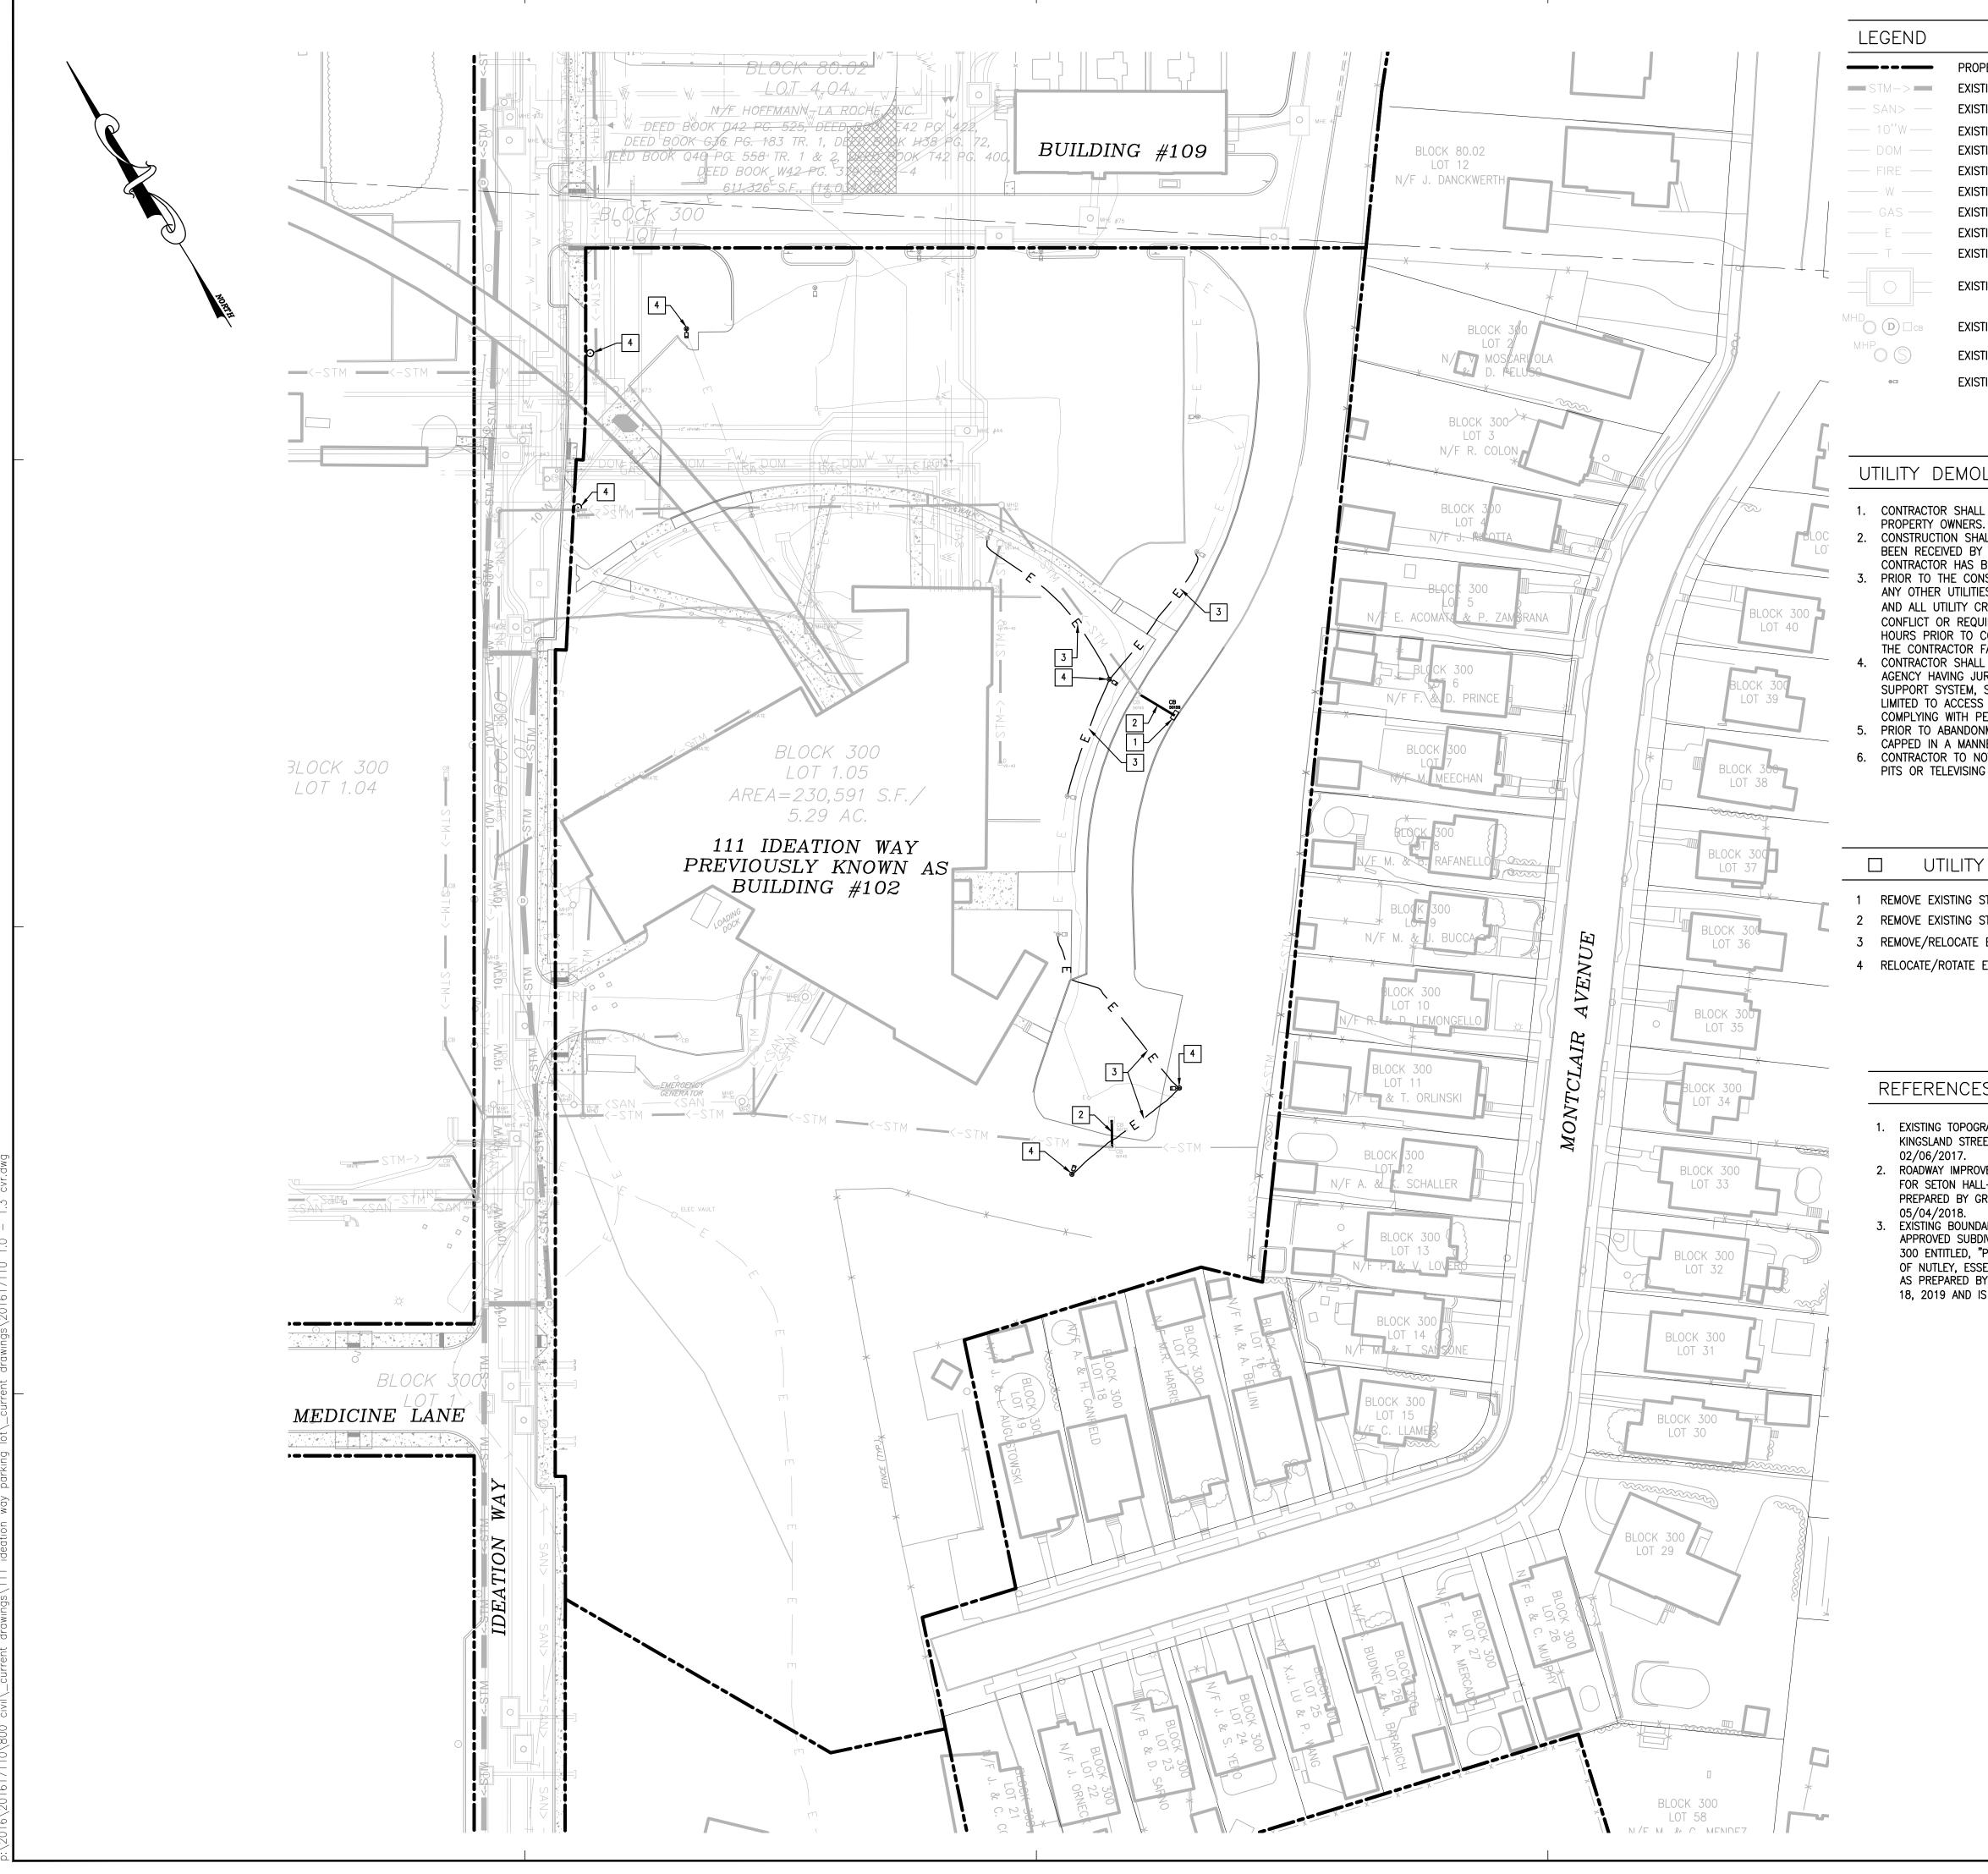

1D				
	PROPERTY LINE	STM->	EXISTING STORM LINE TO BE REMOVED	92 Eas Somer
_	EXISTING STORM LINE TO REMAIN	—— E ——	EXISTING ELECTRIC LINE TO BE REMOVED	t: 732-
	EXISTING SANITARY LINE TO REMAIN	0 -3	EXISTING LIGHT STRUCTURE TO BE RELOCATED	
	EXISTING 10" WATER MAIN TO REMAIN	мнрО□СВ	EXISTING STORM STRUCTURE TO BE REMOVED	
	EXISTING DOMESTIC WATER LINE TO REMAIN			
	EXISTING FIRE WATER LINE TO REMAIN			
	EXISTING CHILLED WATER LINE TO REMAIN			(P)
	EXISTING GAS LINE TO REMAIN			
	EXISTING ELECTRIC LINE TO REMAIN			
	EXISTING TELEPHONE LINE TO REMAIN			7
	EXISTING UTILITY & STRUCTURE TO REMAIN			ATTU STA
]св	EXISTING STORM STRUCTURE TO REMAIN			
	EXISTING SANITARY MANHOLE TO REMAIN			
	EXISTING LIGHT STRUCTURE TO REMAIN			This draw referenced for any project c be repro express w

UTILITY DEMOLITION NOTES

CONTRACTOR SHALL COORDINATE ANY DISRUPTIONS TO EXISTING UTILITY SERVICES WITH THE AFFECTED

2. CONSTRUCTION SHALL NOT START ON ANY PUBLIC OR PRIVATE UTILITY SYSTEM UNTIL WRITTEN APPROVAL HAS BEEN RECEIVED BY THE ENGINEER FROM THE APPROPRIATE GOVERNING AUTHORITY OR UTILITY COMPANY AND CONTRACTOR HAS BEEN NOTIFIED BY THE ENGINEER TO PROCEED.

PRIOR TO THE CONSTRUCTION OF OR CONSTRUCTION TO ANY STORM DRAIN, SANITARY SEWER, WATER MAIN OR ANY OTHER UTILITIES, THE CONTRACTOR SHALL EXCAVATE, VERIFY AND CALCULATE ALL POINTS OF CONNECTION AND ALL UTILITY CROSSINGS AND INFORM GREENBERGFARROW ENGINEERS AND THE OWNER/DEVELOPER OF ANY CONFLICT OR REQUIRED DEVIATIONS FROM THE PLAN. NOTIFICATION SHALL BE MADE A MINIMUM OF (72) HOURS PRIOR TO CONSTRUCTION. ENGINEER AND ITS CLIENTS SHALL BE HELD HARMLESS IN THE EVENT THAT THE CONTRACTOR FAILS TO MAKE SUCH NOTIFICATION. CONTRACTOR SHALL COMPLY COMPLETELY WITH THE LATEST STANDARDS OF OSHA DIRECTIVES OR ANY OTHER

AGENCY HAVING JURISDICTION FOR EXCAVATION AND TRENCHING PROCEDURES. THE CONTRACTOR SHALL USE A SUPPORT SYSTEM, SLOPING, BENCHING AND OTHER MEANS OF PROTECTION. THIS IS TO INCLUDE, BUT NOT LIMITED TO ACCESS AND EGRESS FROM ALL EXCAVATION AND TRENCHING. CONTRACTOR IS RESPONSIBLE FOR COMPLYING WITH PERFORMANCE CRITERIA AS REQUIRED BY OSHA. PRIOR TO ABANDONMENT OF ANY PIPE, IT IS REQUIRED TO BE CUT, FILLED WITH FLOWABLE CONCRETE AND

CAPPED IN A MANNER ACCEPTABLE TO ALL JURISDICTIONAL AUTHORITIES. 6. CONTRACTOR TO NOTIFY THE MUNICIPAL ENGINEER AND ENGINEER OF RECORD 48 HOURS PRIOR TO ANY TEST PITS OR TELEVISING OF SEWER LINES.

UTILITY DEMOLITION KEY NOTES

1 REMOVE EXISTING STORM DRAINAGE STRUCTURE

2 REMOVE EXISTING STORM DRAINAGE PIPE

3 REMOVE/RELOCATE EXISTING SITE LIGHTING ELECTRICAL LINES 4 RELOCATE/ROTATE EXISTING LIGHT STRUCTURE

REFERENCES

1. EXISTING TOPOGRAPHIC SURVEY BASED ON PLAN ENTITLED "340 KINGSLAND STREET" PREPARED BY KELLER & KIRKPATRICK INC., DATED 02/06/2017.


2. ROADWAY IMPROVEMENTS BASED ON PLAN ENTITLED "ROADWAY DESIGN FOR SETON HALL-HACKENSACK MERIDIAN SCHOOL OF MEDICINE", PREPARED BY GREENBERGFARROW, DATED 01/03/2017, LAST REVISED 05/04/2018. 3. EXÍSTING BOUNDARY INFORMATION IS BASED OFF PREVIOUSLY

APPROVED SUBDIVISION PREPARED FOR LOTS 1.05 & 1.06, BLOCK 300 ENTITLED, "PRELIMINARY & FINAL MAJOR SUBDIVISION, TOWNSHIP OF NUTLEY, ESSEX COUNTY NEW JERSEY" DATED DECEMBER 20, 2018 AS PREPARED BY PS&S. THE PLAT WAS RECORDED ON DECEMBER 18, 2019 AND IS IDENTIFIED AS MAP #4711.

GreenbergFarrow . COA#: GA280797

Main Street, Suite 410 ille, NJ 08876 37-0811



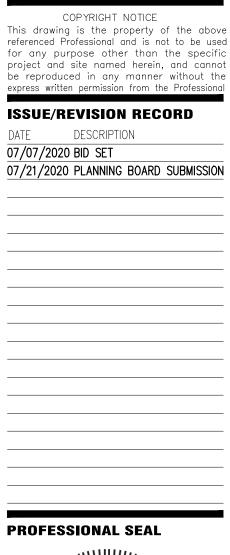





PROFESSIONAL ENGINEER LICENSE NO. 24GE04773100 **PROJECT MANAGER** RICHARD PROCANIK QUALITY CONTROL RICHARD PROCANIK DRAWN BY

THOMAS WIENCKOWSKI PROJECT NAME

111 IDEATION WAY PARKING LOT

NUTLEY **NEW JERSEY**

EXISTING BLOCK 3	300 LOT 1 & 1.05
PROPOSED LOT 1.	05A
TOWNSHIP OF NU	TLEY
ESSEX COUNTY, N	IJ
ZONING DISTRICT:	RRP-2A
	ROCHE
	REDEVELOPMENT
	PLAN PHASE IIA


PROJECT NUMBER 20161711.0


SHEET TITLE

UTILITY DEMOLITION PLAN

SHEET NUMBER

1.3

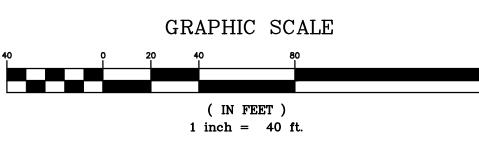

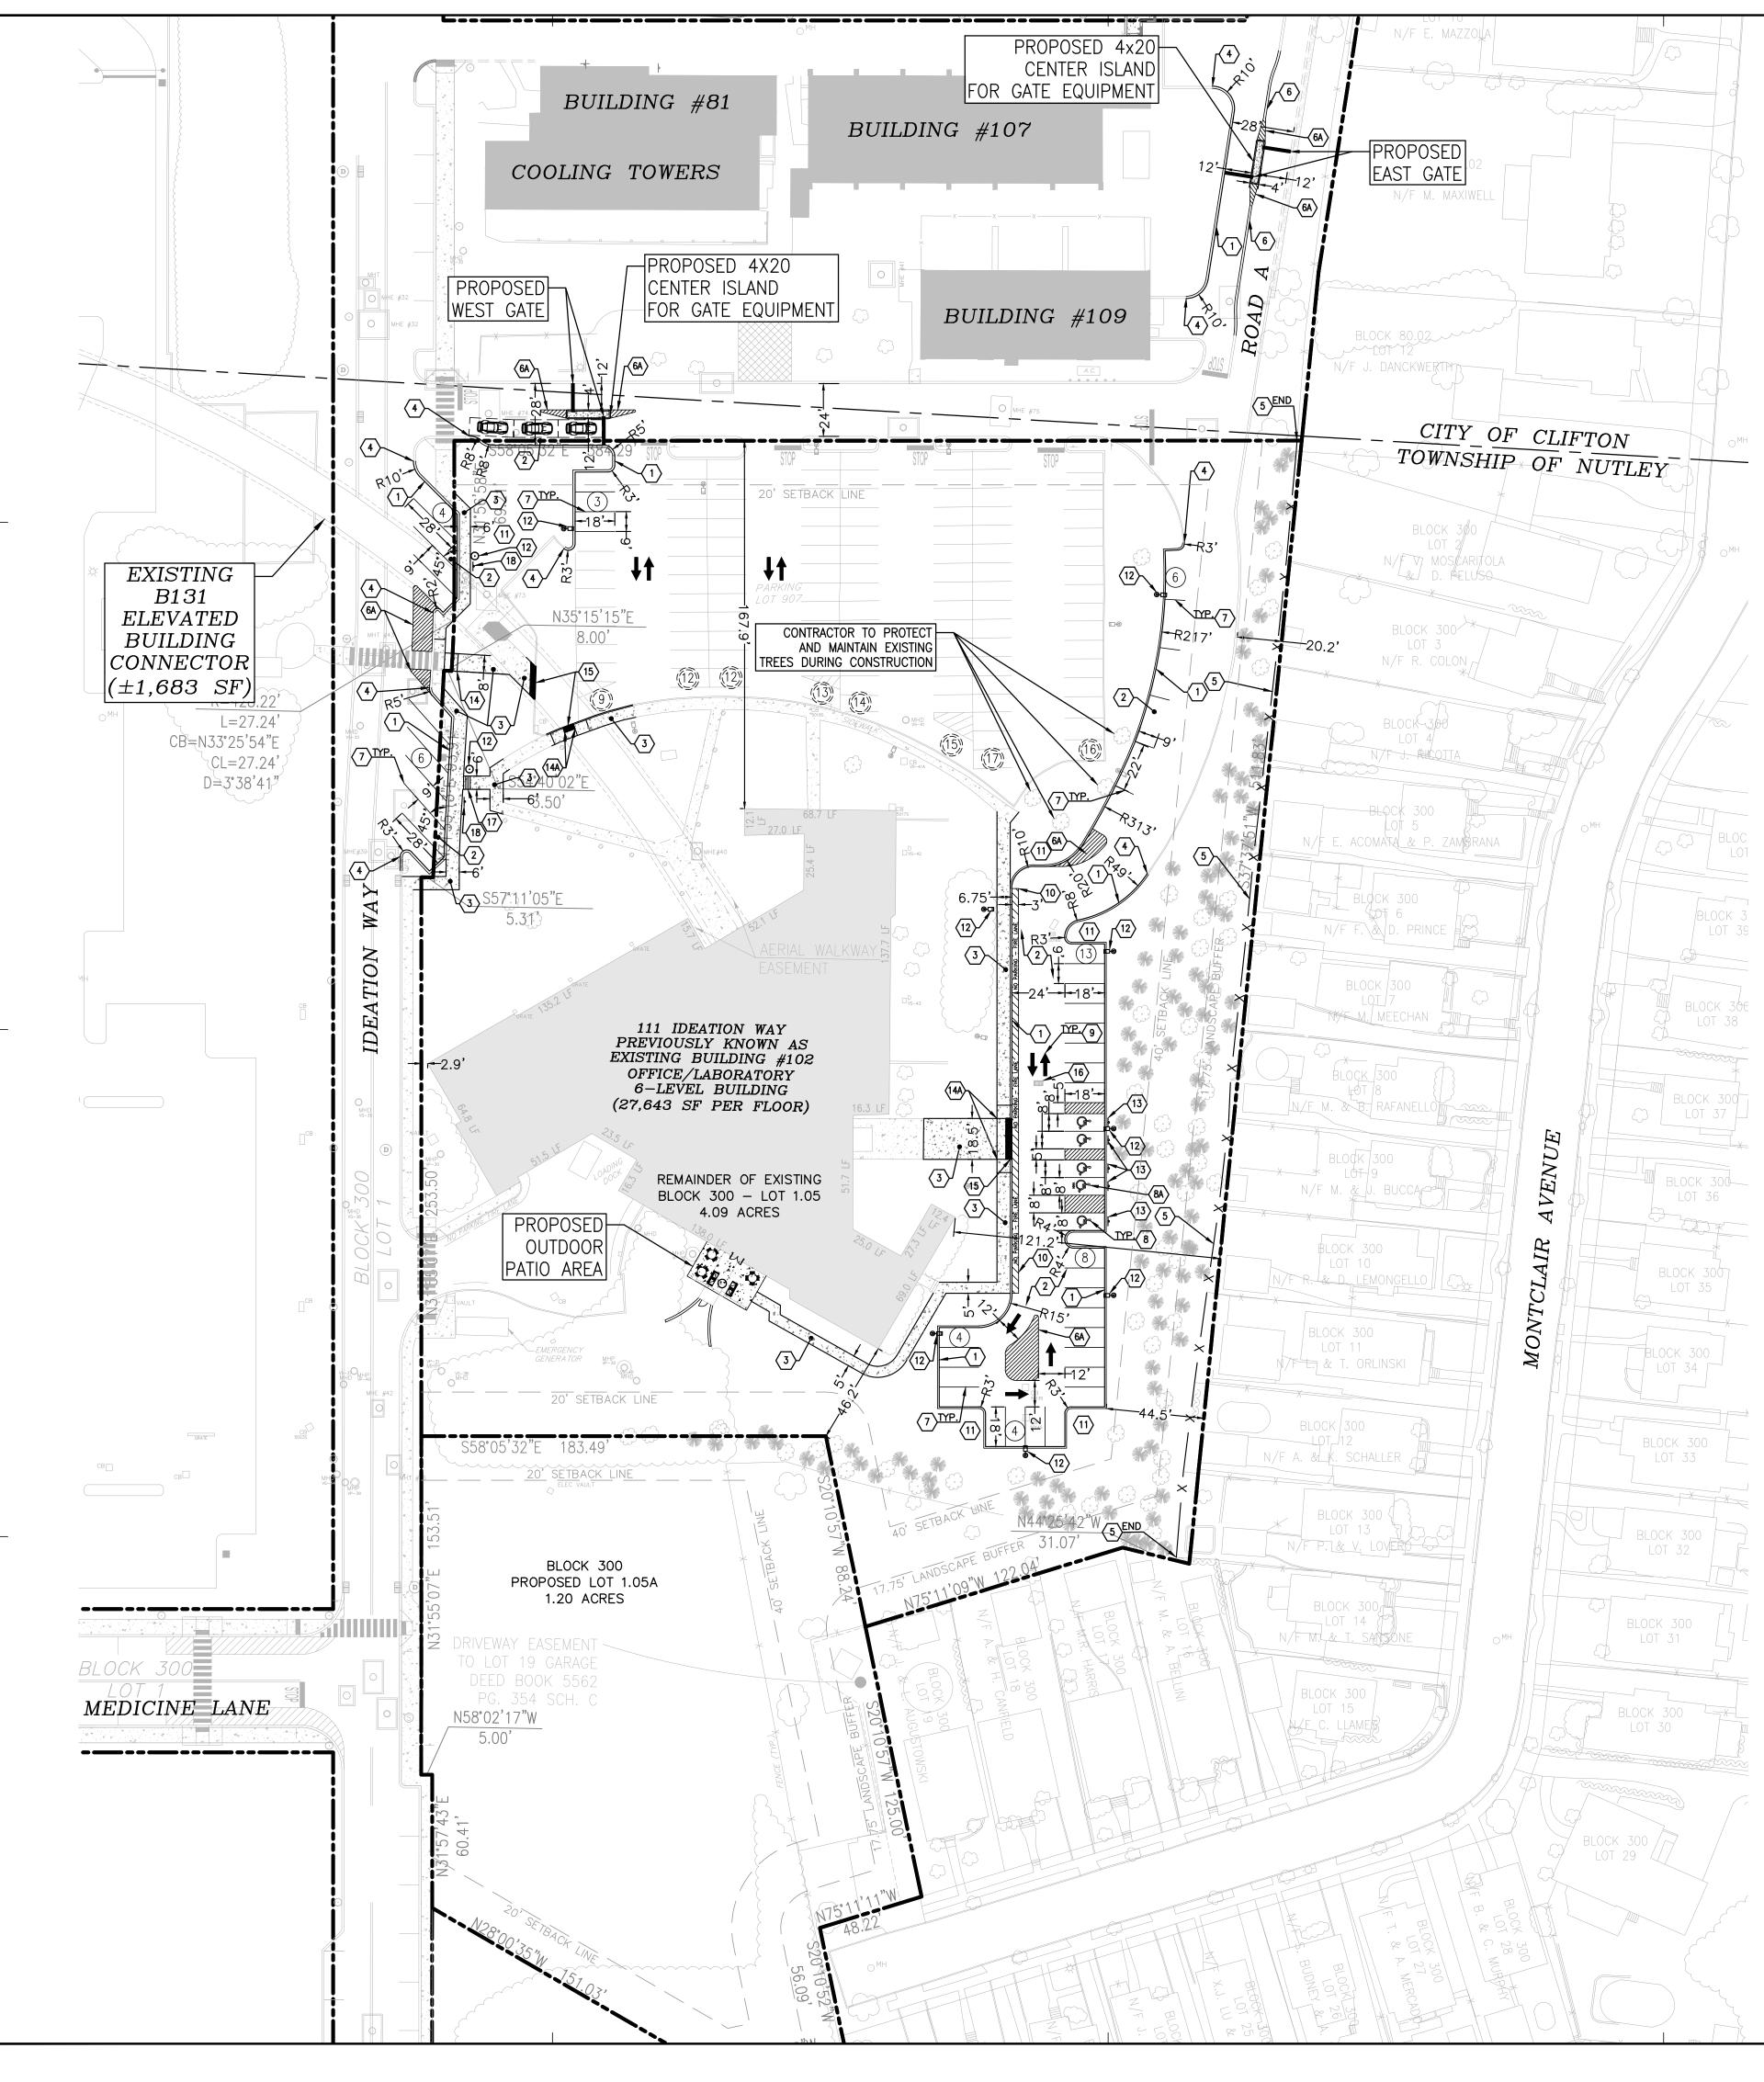

LEGEND ---- PROP ____ SETBA EASEM EXISTIN EXISTIN EXISTI EXISTIN EXISTIN EXISTI SITE LAYOUT KEY NOTES PROPOSED CONCRETE CURB PROPOSED ASPHALT PAVEMENT PROPOSED CONCRETE SIDEWALK PROPOSED 6' HIGH FENCE 5

- PROPOSED PAVEMENT MARKING PARKING SPACE 8A PROPOSED PAVEMENT MARKING - DIRECTIONAL ARROWS 9 10 PROPOSED PAVEMENT MARKING - NO PARKING - FIRE LANE 11 PROPOSED LANDSCAPE AREA 12 PROPOSED/RELOCATED SITE LIGHTING FIXTURE 13 PROPOSED ADA PARKING SIGN 14 PROPOSED NJDOT TYPE 5 ADA SIDEWALK RAMP 14A PROPOSED NJDOT TYPE 7 ADA SIDEWALK RAMP 15 PROPOSED FLUSH CURB

- SITE LAYOUT NOTES
- CONTRACTOR MUST SECURE ALL NECESSARY PERMITS PRIOR TO STARTING WORK.
- 3. CONSTRUCTION.
- SPECIFICATIONS AND DETAILS. 5. ALL ACCESSIBLE (ADA) SITE FEATURES SHALL BE CONSTRUCTED TO MEET ALL FEDERAL, STATE, AND LOCAL GUIDELINES.
- THE CONTRACTOR SHALL CAREFULLY PRESERVE BENCHMARKS, REFERENCE POINTS AND STAKES. ALL DIMENSIONS ARE MEASURED FROM FACE OF BUILDING, CURB, AND WALL UNLESS OTHERWISE SPECIFIED ON PLANS. 8. CONTRACTOR SHALL MAINTAIN THE SITE IN A MANNER SO THAT WORKMEN AND PUBLIC SHALL BE PROTECTED FROM INJURY, AND ADJOINING PROPERTY
- PROTECTED FROM DAMAGE.

120 STALLS

135 STALLS

6 STALLS

1 STALLS 146 STALLS

STALLS

10 STALLS

- 9. CONTRACTOR IS RESPONSIBLE FOR DAMAGE TO ANY EXISTING ITEMS AND/OR MATERIAL INSIDE OR OUTSIDE CONTRACT LIMITS DUE TO CONSTRUCTION OPERATIONS.
- 10. ALL ROADWORK SHALL BE PERFORMED IN ACCORDANCE WITH THE STATE AND LOCAL GOVERNMENT AGENCY SPECIFICATIONS. 11. NO HAZARDOUS WASTE GENERATED OFF-SITE MAY BE STORED ON THE SUBJECT SITE FOR ANY PERIOD OF TIME IN ACCORDANCE WITH SECTION 6.3(0)3 OF
- THE REDEVELOPMENT PLAN. 12. CONTRACTOR TO REPLACE ANY CURBS, SIDEWALKS, LANDSCAPING, ETC. THAT IS DISTURBED DURING CONSTRUCTION OUTSIDE LIMITS OF DISTURBANCE.

PARKING CALCULATION

111 IDEATION WAY EXISTING PARKING SPACES

PROPOSED STANDARD PARKING SPACES PROPOSED PARALLEL PARKING SPACES PROPOSED ADA STANDARD ACCESSIBLE PARKING SPACES 4 STALLS PROPOSED ADA VAN ACCESSIBLE PARKING SPACES TOTAL PROPOSED PARKING SPACES

NET INCREASE OF 26 PARKING SPACES

IDEATION WAY STREET PARKING

EXISTING PARALLEL PARKING SPACES PROPOSED ANGLED PARKING SPACES

NET INCREASE OF 3 PARKING SPACES

OVERALL NET INCREASE OF 29 PARKING SPACES

erty line Ck line	X	PR0 PR0
IENT LINE		PRO
NG CURB		
NG WALL	<u> </u>	PRO
NG FENCE		PRO
NG GUIDE RAIL	(22)	NUM
NG TREE	<u> </u>	PRC
NG TREE LINE	6 3	PRC
		PRO

OPOSED CURB DPOSED FENCE OPOSED CONCRETE SIDEWALK

OPOSED ADA ACCESSIBLE PARKING OPOSED STRIPING MBER OF PARKING SPACES OPOSED SIGN OPOSED/RELOCATED SITE LIGHTING FIXTURE DPOSED STORM DRAINAGE 'TYPE A' INLET STRUCTURE GreenbergFarrow

92 East Main Street, Suite 410

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ISSUE/REVISION RECORD

DESCRIPTION

07/21/2020 PLANNING BOARD SUBMISSION

07/07/2020 BID SET

PROFESSIONAL SEAL

PROFESSIONAL IN CHARGE

LICENSE NO. 24GE04773100

111 IDEATION WAY

EXISTING BLOCK 300 LOT 1 & 1.05

ROCHE

REDEVELOPMENT PLAN PHASE IIA

STEPHEN POWERS

PROFESSIONAL ENGINEER

PROJECT MANAGER

QUALITY CONTROL

THOMAS WIENCKOWSKI

PROJECT NAME

PARKING LOT

NUTLEY

NEW JERSEY

PROPOSED LOT 1.05A

TOWNSHIP OF NUTLEY

PROJECT NUMBER

20161711.0

SHEET TITLE

SHEET NUMBER

LAYOUT

2.0

PLAN

ESSEX COUNTY, NJ ZONING DISTRICT: RRP-2A

RICHARD PROCANIK

RICHARD PROCANIK

DRAWN BY

DATE

Somerville, NJ 08876

t: 732-537-0811

- PROPOSED CURB TIE-IN LOCATION. CONNECTION TO BE SMOOTH AND EVEN
- PROPOSED PAVEMENT MARKING SOLID DOUBLE 4" YELLOW STRIPE 6A PROPOSED PAVEMENT MARKING - SOLID 4" YELLOW STRIPES AT 3'-0" ON CENTER


 - PROPOSED PAVEMENT MARKING ADA ACCESSIBLE PARKING SPACE
- PROPOSED PAVEMENT MARKING ADA VAN ACCESSIBLE PARKING SPACE
- 16 PROPOSED STORM DRAINAGE TYPE 'A' INLET STRUCTURE
- 17 PROPOSED (4) STAIRS WITH 6" RISERS
- 18 PROPOSED "RESERVED PARKING FOR 111 IDEATION WAY" SIGN

2. IF THE CONTRACTOR IN THE COURSE OF THE WORK, FINDS ANY DISCREPANCIES BETWEEN THE PLANS AND THE PHYSICAL CONDITIONS OF THE LOCALITY, OR ANY ERRORS OR OMISSIONS IN THE PLANS OR IN THE LAYOUT THE ENGINEER SHALL BE NOTIFIED IN WRITING AND THE ENGINEER WILL PROMPTLY VERIFY THE SAME. ANY WORK DONE AFTER SUCH A DISCOVERY, UNTIL AUTHORIZED, WILL BE AT THE CONTRACTOR'S RISK. CONTRACTOR SHALL BE RESPONSIBLE FOR VERIFICATION OF ALL SETBACKS, EASEMENTS, AND DIMENSIONS SHOWN HEREON BEFORE BEGINNING

4. ALL CONSTRUCTION MATERIALS AND WORKMANSHIP SHALL BE IN ACCORDANCE WITH THE STATE AND LOCAL GOVERNMENT AGENCY'S LATEST CONSTRUCTION

GRAPHIC SCALE

(IN FEET) 1 inch = 40 ft.

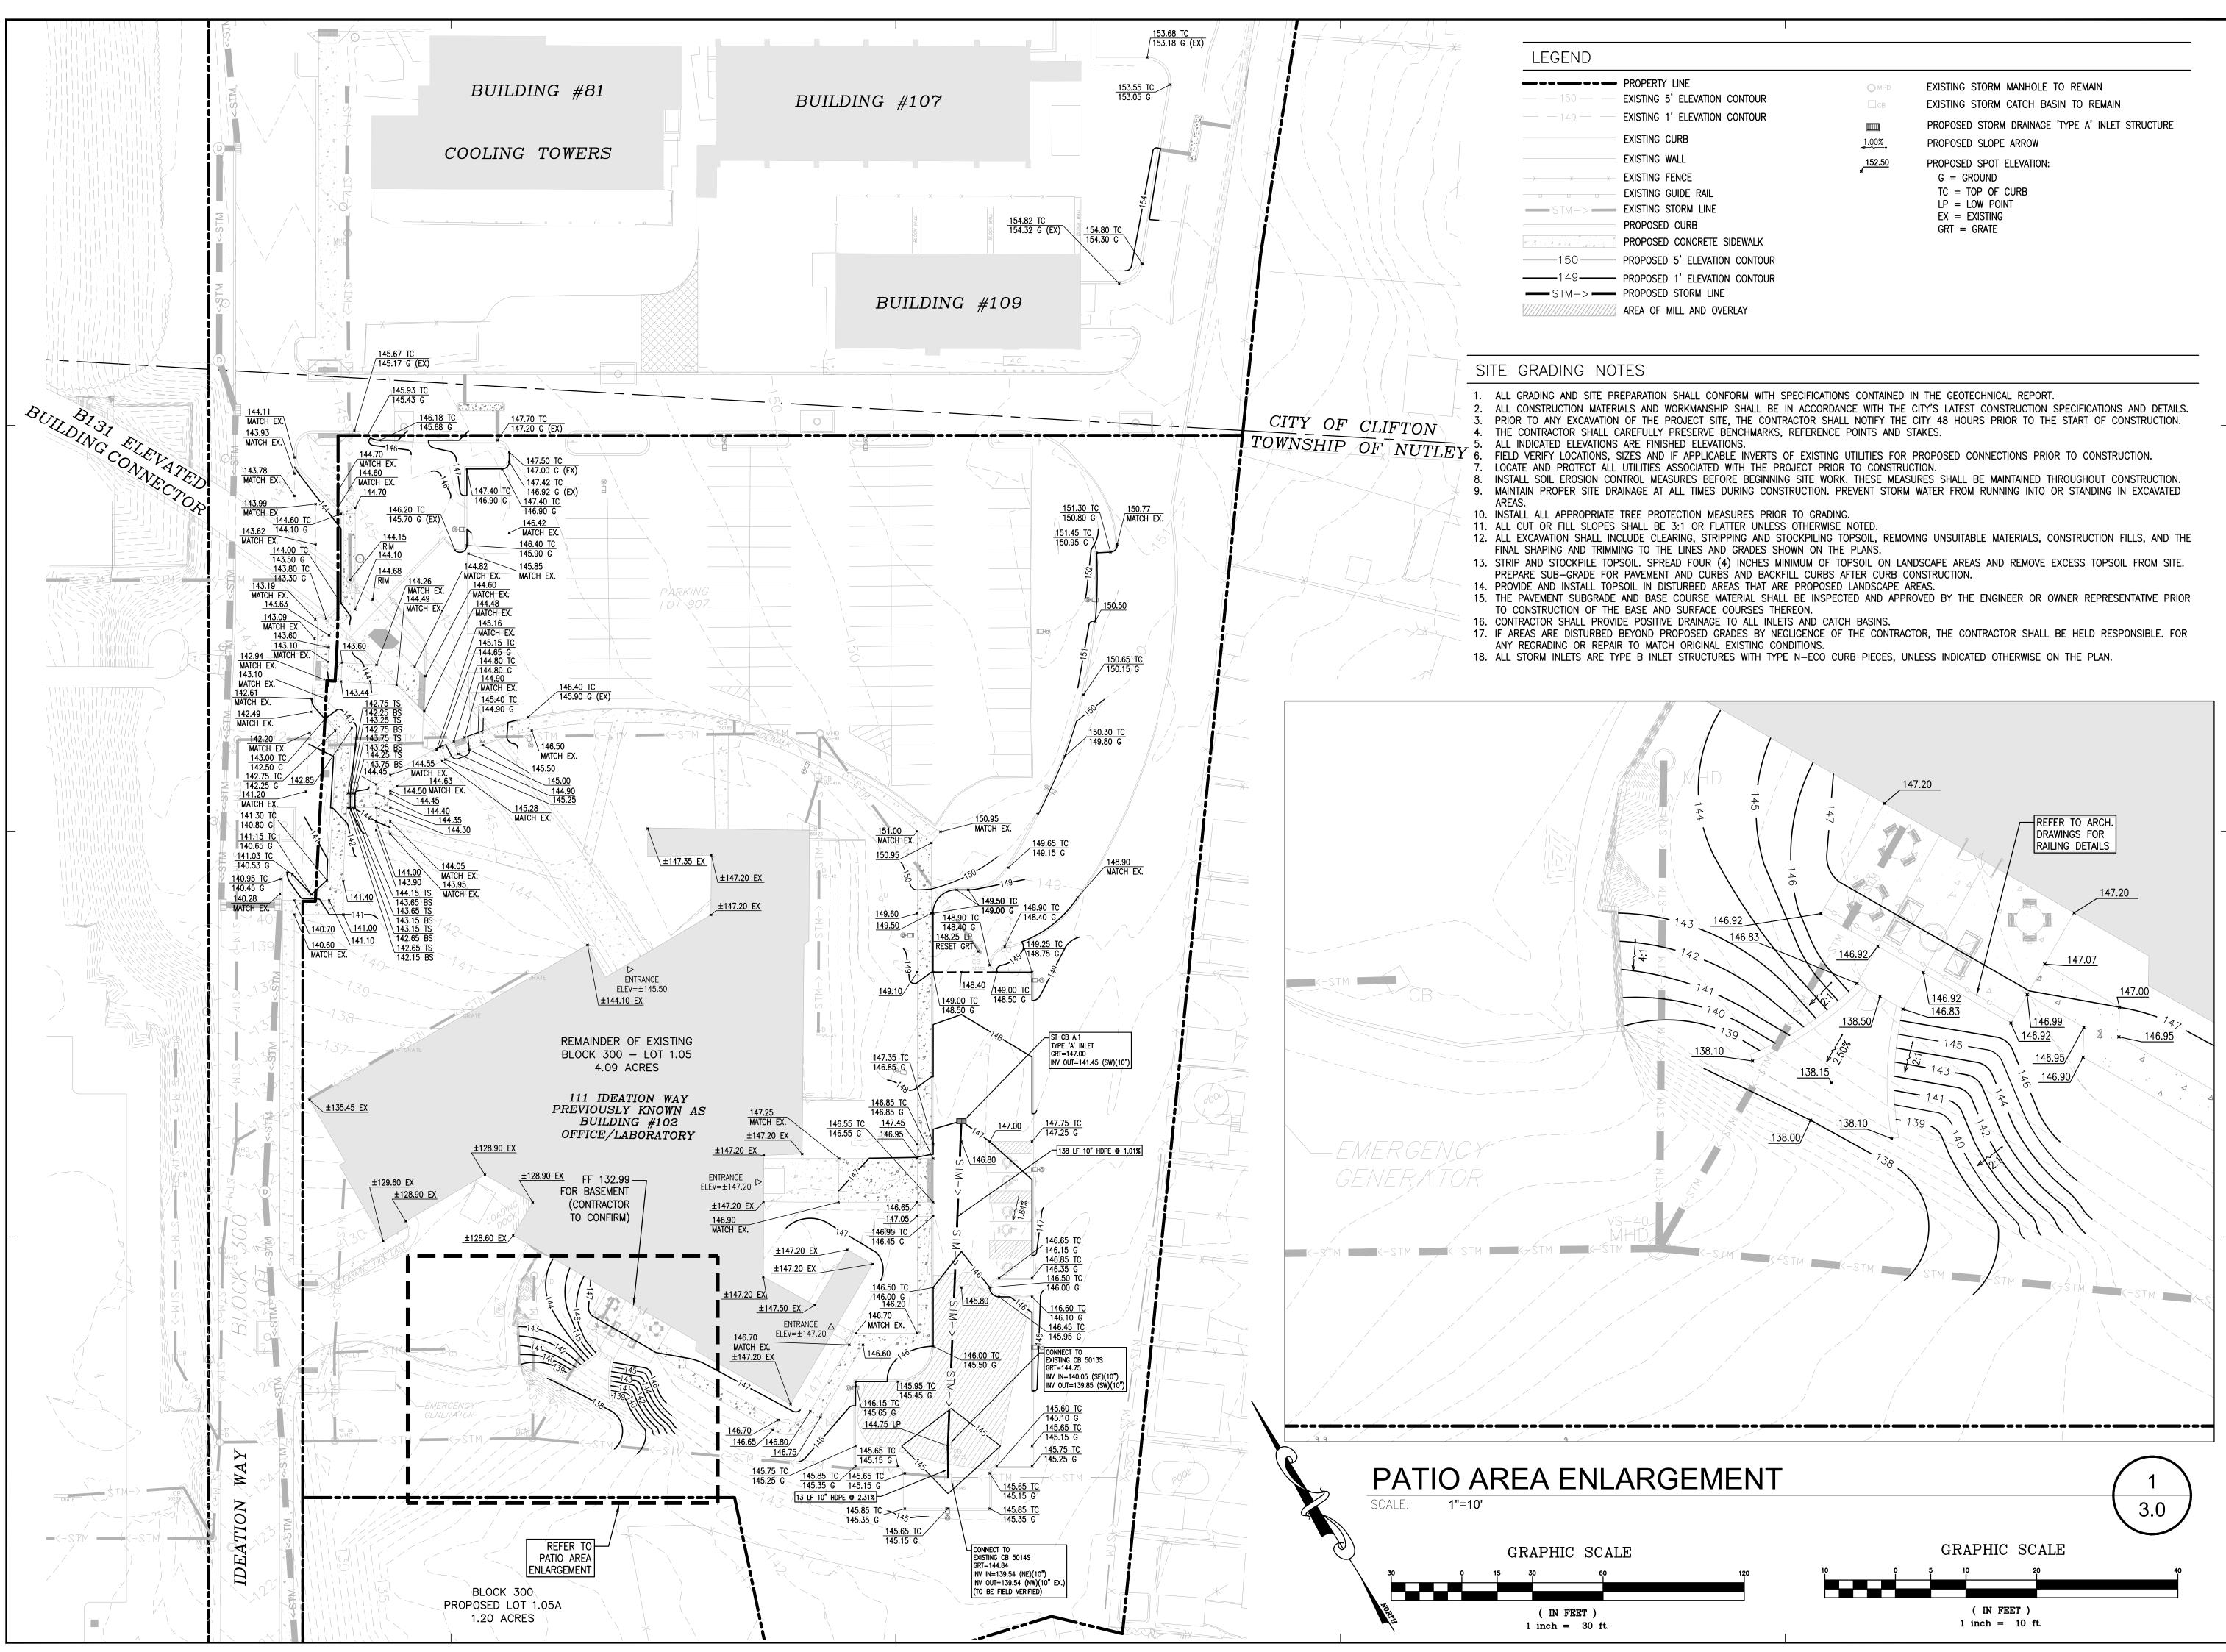

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EXISTING BLOCK 300 LOT 1 & 1.05 PROPOSED LOT 1.05A TOWNSHIP OF NUTLEY

ROCHE REDEVELOPMENT PLAN PHASE IIA

NUTLEY **NEW JERSEY**

ESSEX COUNTY, NJ ZONING DISTRICT: RRP-2A

PROJECT NUMBER

GRADING AND

SHEET NUMBER

3.0

DRAINAGE PLAN

20161711.0

SHEET TITLE

PARKING LOT

DRAWN BY THOMAS WIENCKOWSKI **PROJECT NAME 111 IDEATION WAY**

PROJECT MANAGER RICHARD PROCANIK QUALITY CONTROL RICHARD PROCANIK


LICENSE NO. 24GE04773100

PROFESSIONAL ENGINEER

PROFESSIONAL IN CHARGE STEPHEN POWERS

PROFESSIONAL SEAL


GreenbergFarrow

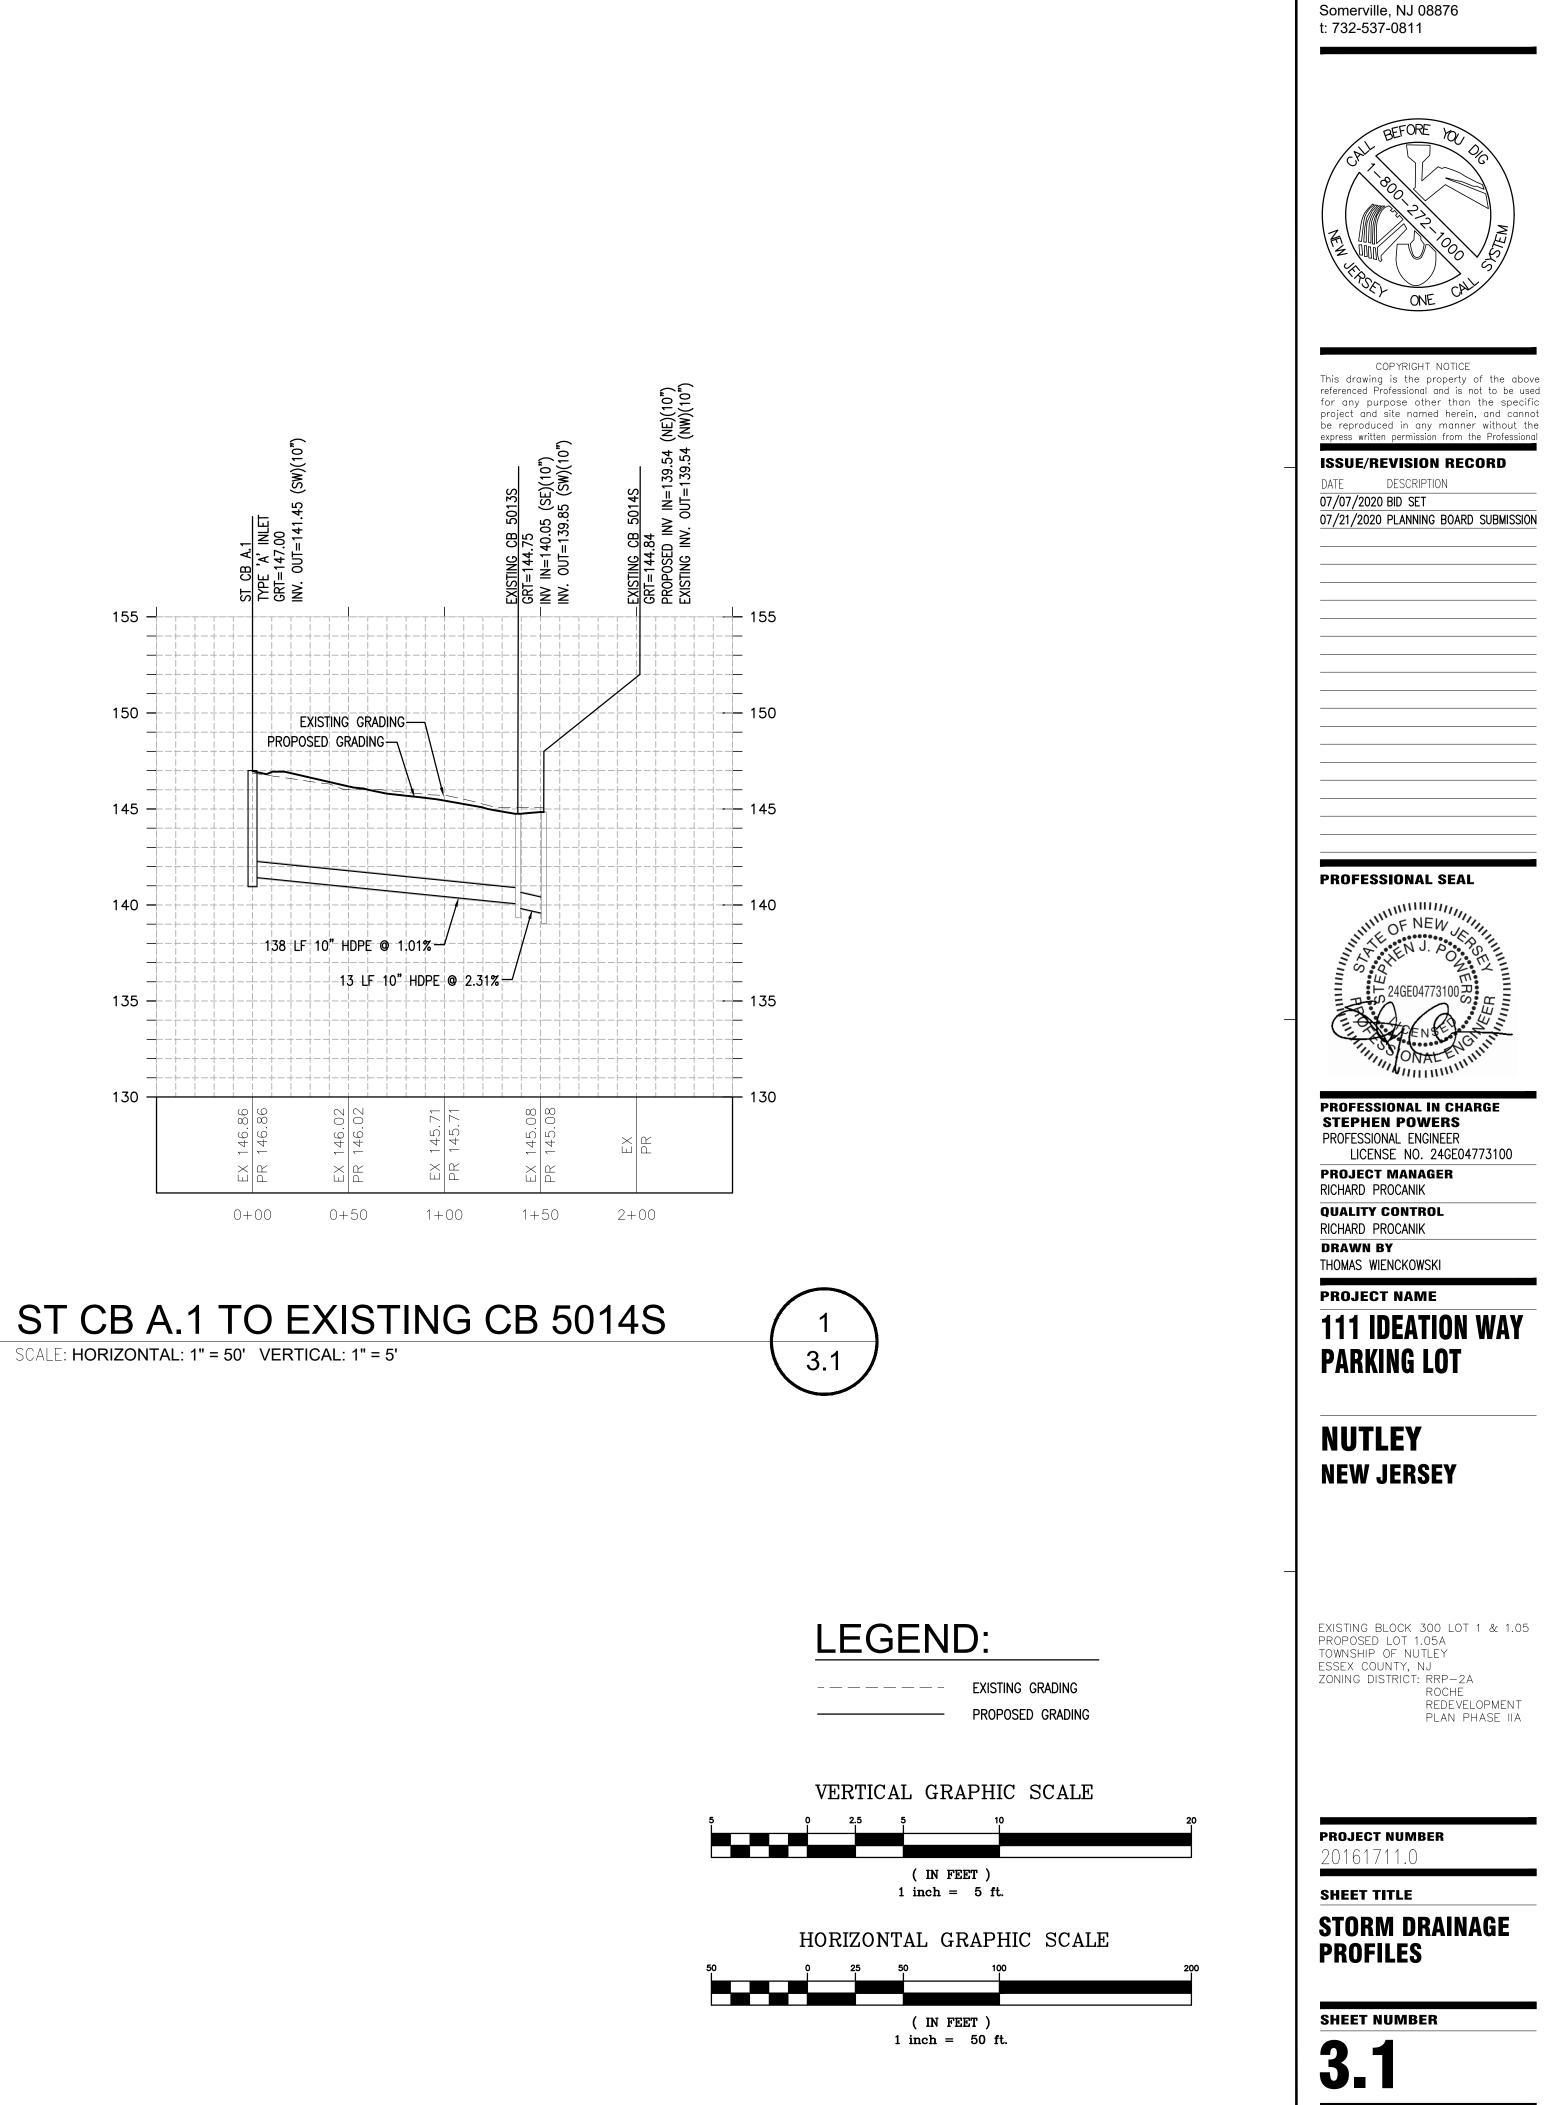

SCALE: HORIZONTAL: 1" = 50' VERTICAL: 1" = 5'

92 East Main Street, Suite 410

COA#: GA280797

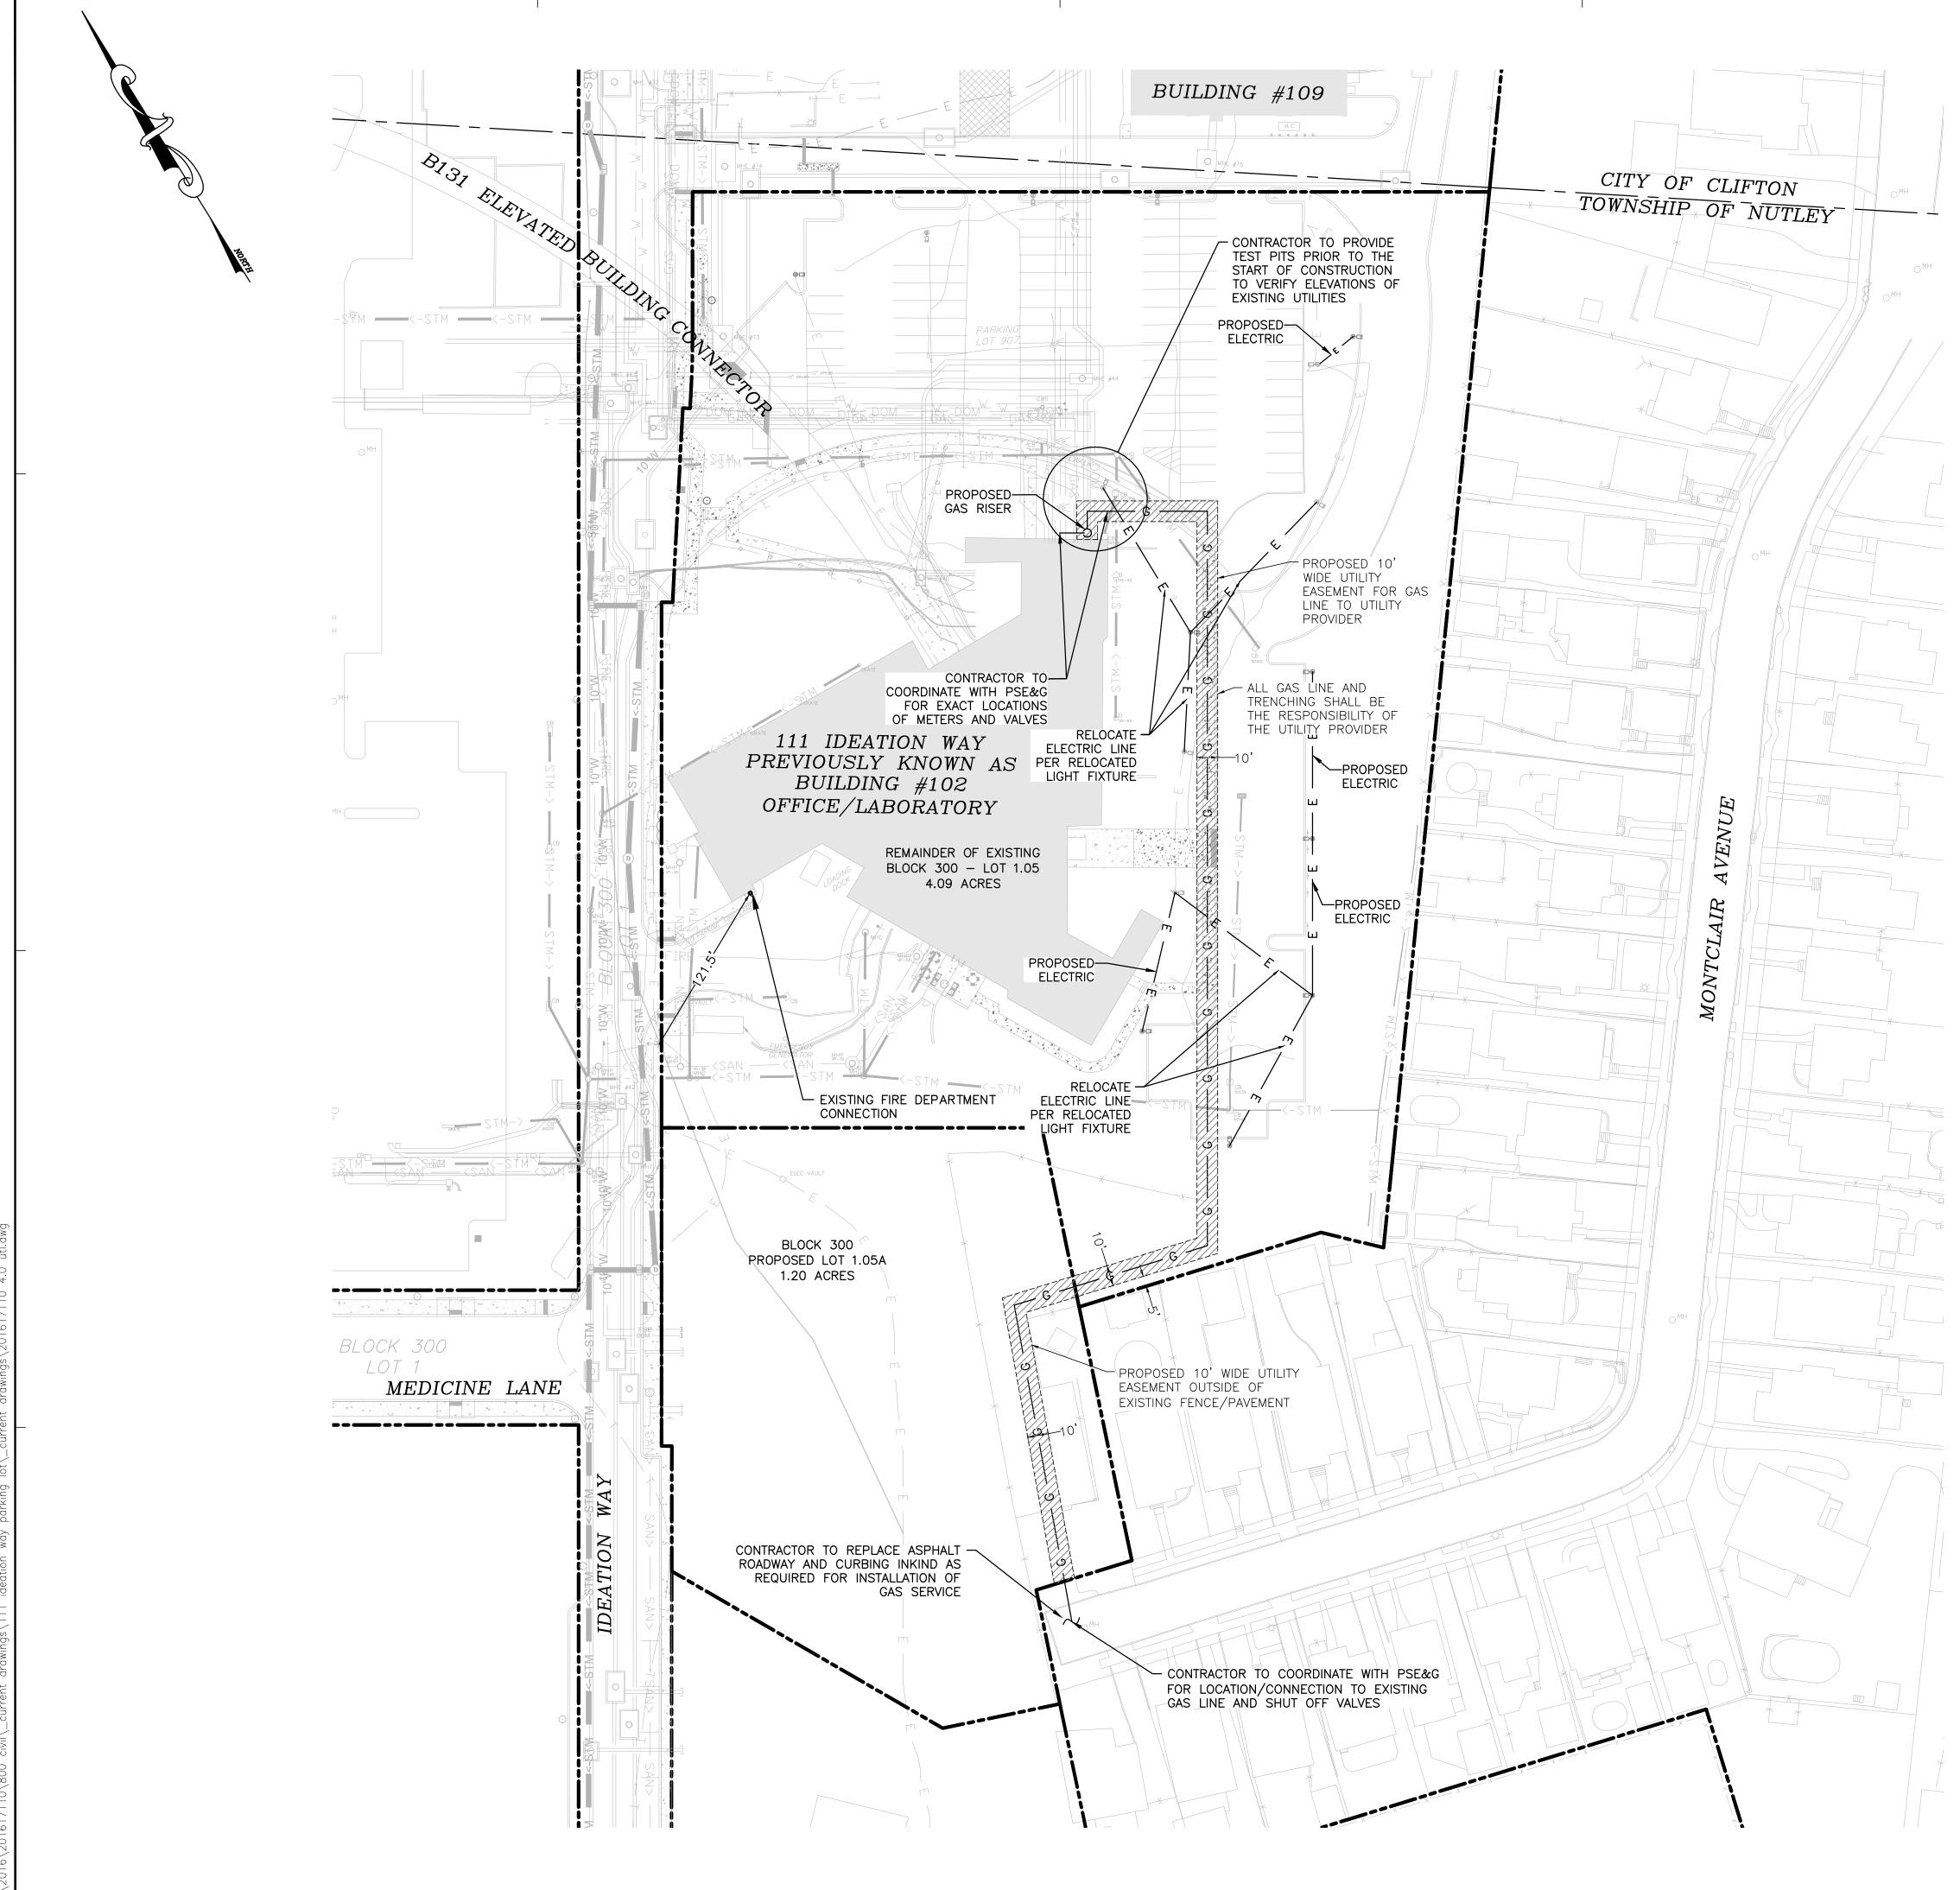

GENERAL GAS UTILITY NOTES


- CONTRACTOR IS TO VERIFY THE LOCATION OF ALL EXISTING UTILITIES PRIOR TO CONSTRUCTION AND ENSURE NO CONFLICTS EXIST WITH PROPOSED IMPROVEMENTS. THE ENGINEER IS TO BE NOTIFIED IMMEDIATELY IF ANY UTILITIES ARE LOCATED DIFFERENTLY THAN SHOWN. THE CONTRACTOR SHALL COORDINATE WITH EACH RESPECTIVE UTILITY COMPANY IN ORDER TO RELOCATE IF NEEDED CONFORMANCE WITH THEIR GUIDELINES.
- 2. THE CONTRACTOR SHALL BE RESPONSIBLE FOR VERIFYING, PRIOR TO CONSTRUCTION, ALL EXISTING LOCATIONS AND INVERT ELEVATIONS OF SANITARY SEWERS, STORM DRAINAGE, WATER MAINS, ELECTRICAL CONDUITS AND BUILDING UTILITIES WITHIN THE PATH OF THE PROPOSED GAS LINE.
- THE CONTRACTOR IS TO COORDINATE WITH WITH THE BUILDING PLANS TO ENSURE ACCURACY OF UTILITY CONNECTIONS AND COMPLIANCE WITH LOCAL CODES. 4. ALL SEWERS ARE TO BE MAINTAINED THROUGHOUT CONSTRUCTION, INCLUDING CLEANING OF ANY
- SILT OR DEBRIS ACCUMULATED IN STRUCTURES. 5. ALL SURPLUS EXCAVATED MATERIAL FROM THE TRENCH SHALL BE DISPOSED OFF THE SITE BY THE
- CONTRACTOR. 6. THE CONTRACTOR IS TO COORDINATE EXACT TRENCHING, ROUTING, AND POINT OF TERMINATION WITH ALL UTILITY COMPANIES.
- 7. ALL WORK WITHIN THE RIGHT-OF-WAY SHALL CONFORM TO GOVERNING STATE AND/OR LOCAL SPECIFICATIONS.
- 8. ALL UTILITIES ARE TO BE INSTALLED UNDERGROUND.
- 9. ALL WORK IS TO BE PERFORMED IN ACCORDANCE WITH THE TOWNSHIP OF NUTLEY SPECIFICATIONS.

LEGEND	
	PROPERTY LINE
—— G ——	PROPOSED GAS LINE
— Е —	PROPOSED/RELOCATED ELECTRIC LINE
STM->	PROPOSED STORM LINE
	PROPOSED STORM DRAINAGE 'TYPE B' INLET STRUCTU
@-=1	SITE LIGHT FIXTURE
STM->	EXISTING STORM LINE
SAN>	EXISTING SANITARY LINE
— E —	EXISTING ELECTRIC LINE
10''W	EXISTING 10" WATER MAIN
DOM DOM	EXISTING DOMESTIC WATER LINE
	EXISTING FIRE LINE
	EXISTING UTILITY & STRUCTURE
D	EXISTING STORM MANHOLE
MHP S	EXISTING SANITARY MANHOLE

GreenbergFarrow COA# GA28079

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PROFESSIONAL SEAL

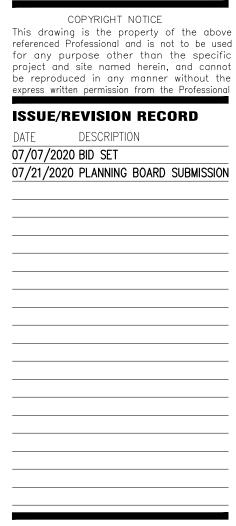

PROFESSIONAL IN CHARGE STEPHEN POWERS PROFESSIONAL ENGINEER LICENSE NO. 24GE04773100 **PROJECT MANAGER** RICHARD PROCANIK

QUALITY CONTROL RICHARD PROCANIK DRAWN BY

THOMAS WIENCKOWSKI PROJECT NAME

111 IDEATION WAY PARKING LOT

NUTLEY **NEW JERSEY**

EXISTING BLOCK 300 LOT 1 & 1.05 PROPOSED LOT 1.05A TOWNSHIP OF NUTLEY ESSEX COUNTY, NJ ZONING DISTRICT: RRP-2A ROCHE


REDEVELOPMENT PLAN PHASE IIA

PROJECT NUMBER 20161711.0


SHEET TITLE UTILITY PLAN

SHEET NUMBER

4.0

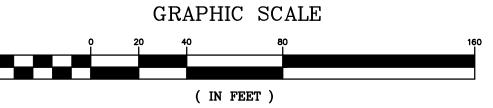

1 inch = 40 ft.

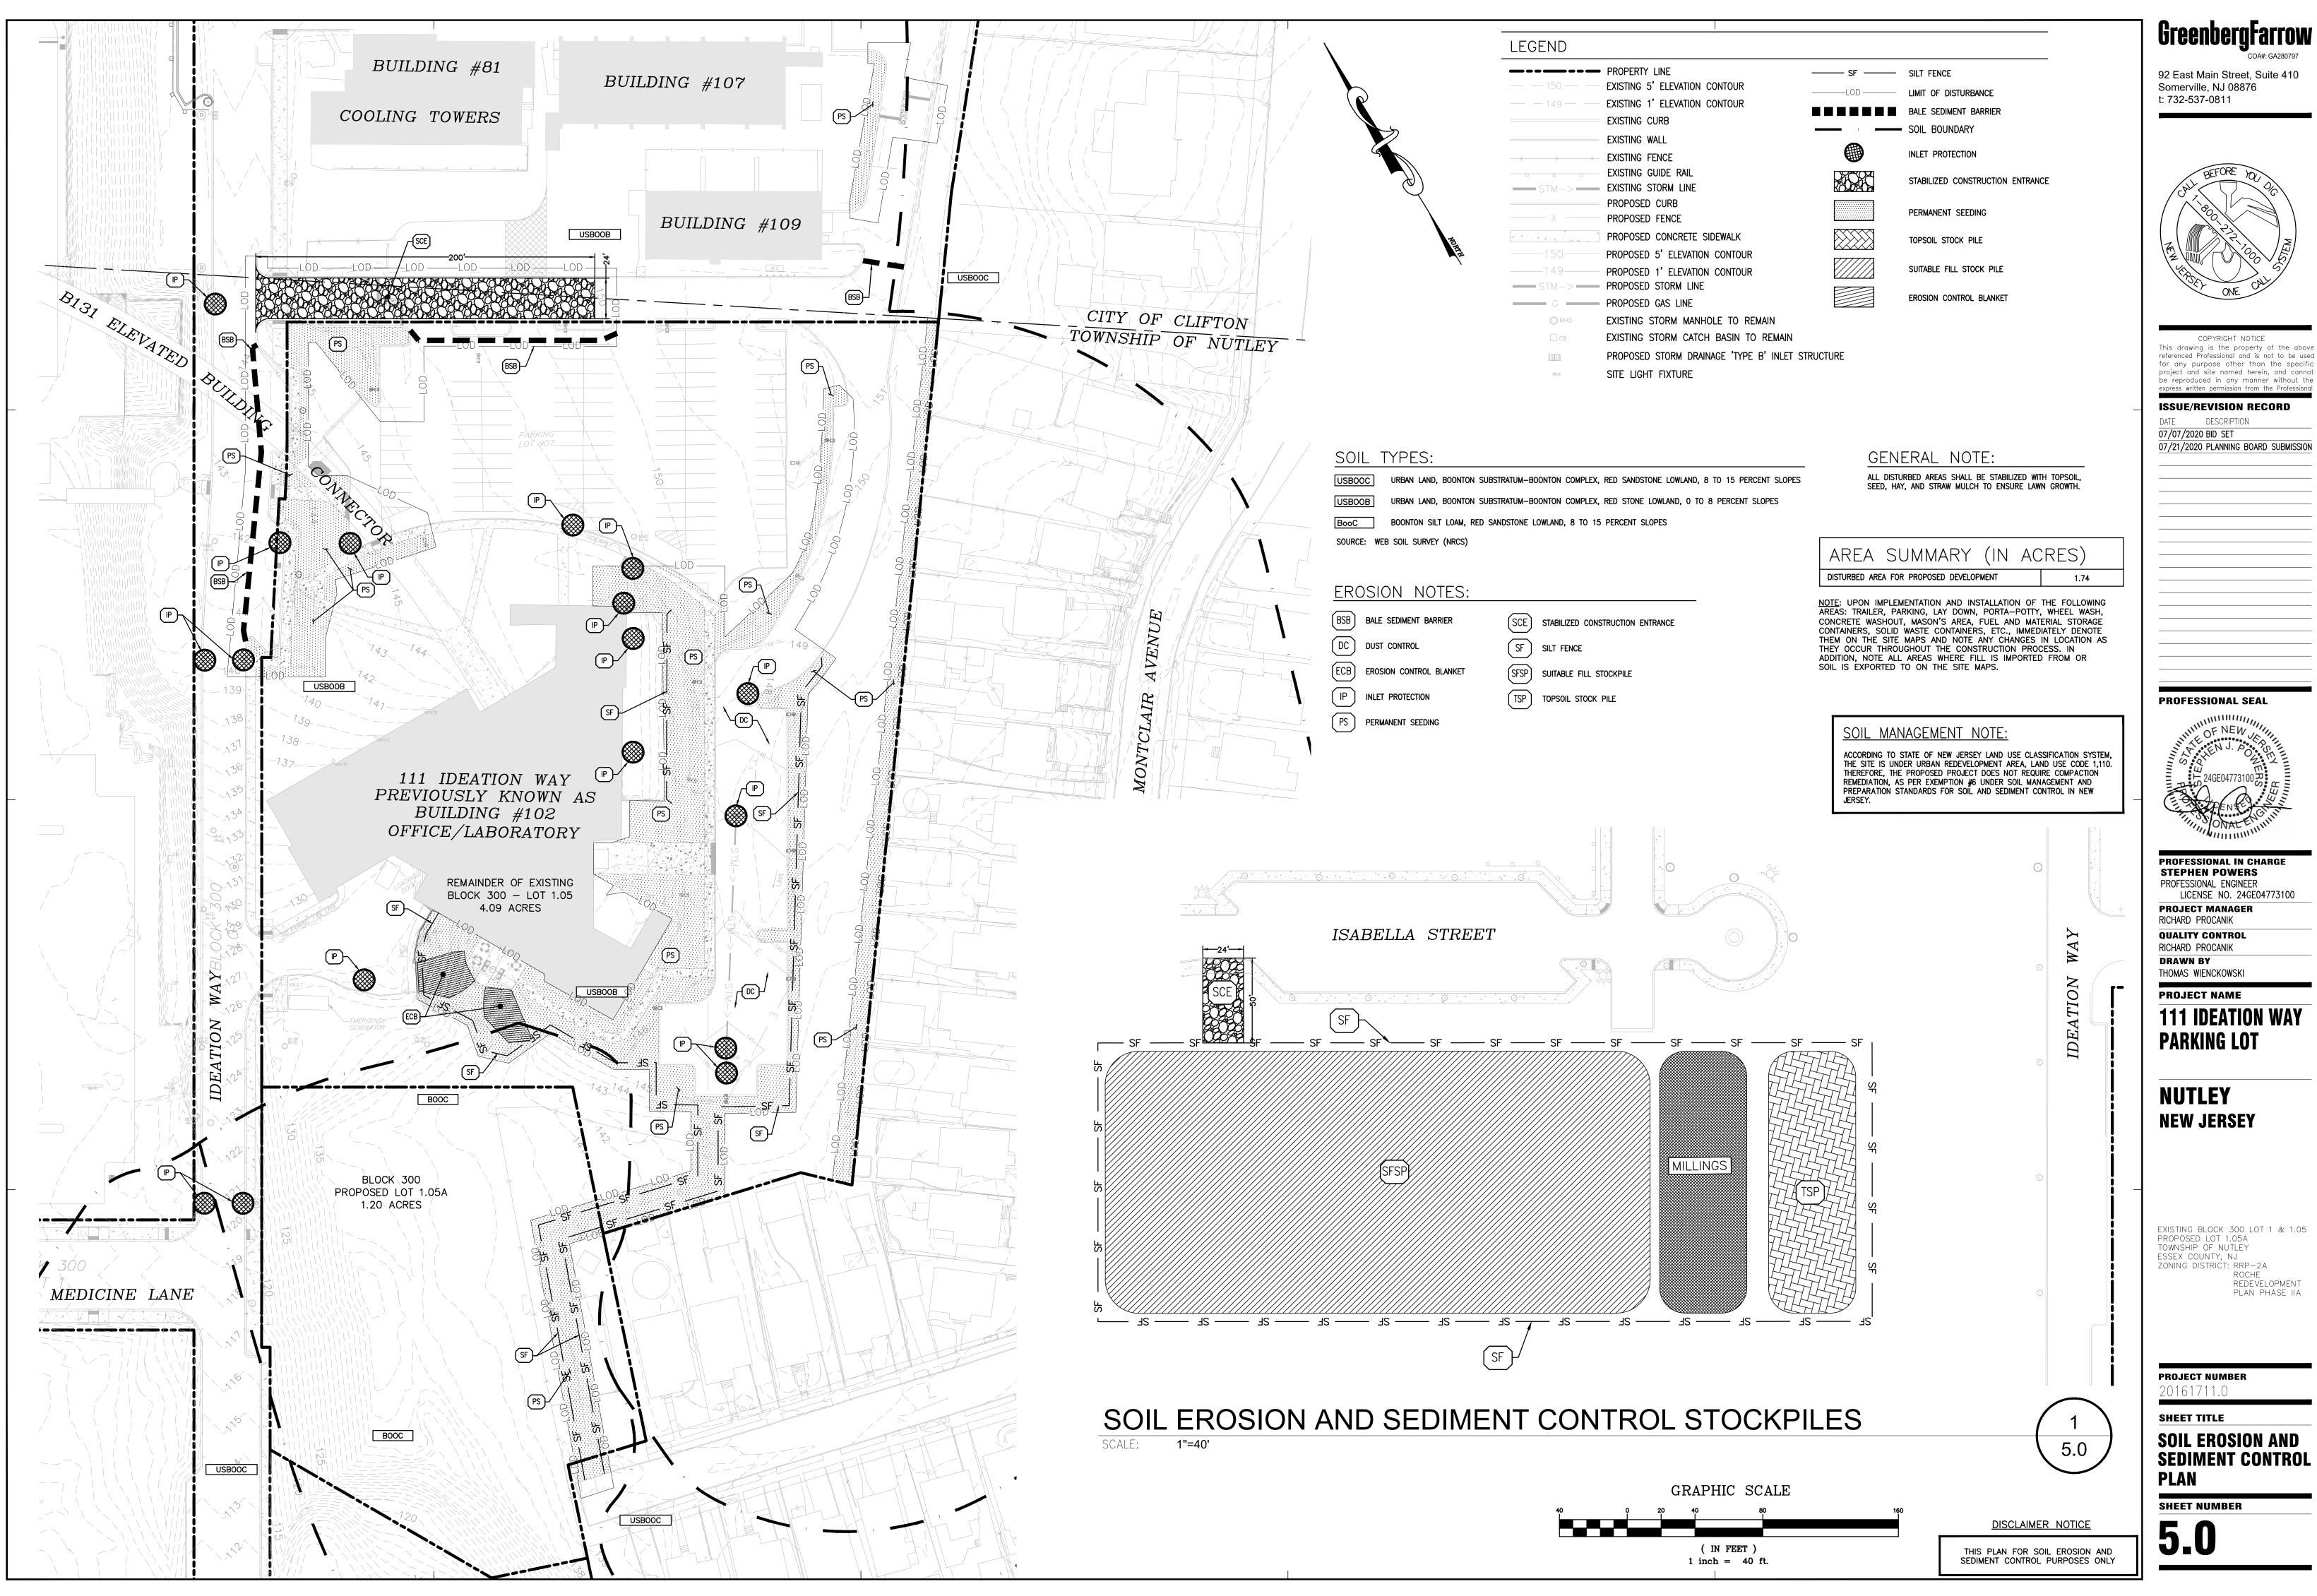

16\201617110\800 civil_current drawings\111 ideation way parking lot_current drawings\201617110 5.0 se&sc.dwg

STANDARD FOR LAND GRADING:

RESHAPING THE GROUND SURFACE BY GRADING TO PLANNED ELEVATIONS WHICH ARE DETERMINED BY TOPOGRAPHIC SURVEY AND LAYOUT.

THE PRACTICE IS FOR ONE OR MORE OF THE FOLLOWING: PROVIDE MORE SUITABLE SITES FOR LAND DEVELOPMENT; IMPROVE SURFACE DRAINAGE

AND CONTROL EROSION.

CONDITION WHERE PRACTICE APPLIES:

THIS PRACTICE IS APPLICABLE WHERE GRADING TO PLANNED ELEVATIONS IS PRACTICAL AND IT IS DETERMINED THAT GRADING IS NEEDED GRADING THAT INVOLVES THE DISTURBANCE OF VEGETATION OVER LARGE AREAS SHALL BE AVOIDED. IT MAY BE NECESSARY TO PROVIDE FOR TEMPORARY STABILIZATION OF LARGE AREAS.

WATER QUALITY ENHANCEMENT:

PROPER GRADING OF DISTURBED SITES WILL PROTECT AGAINST SOIL LOSS FROM EROSION, ENHANCE ESTABLISHMENT OF PERMANENT VEGETATIVE COVER AND HELP TO PROPERLY MANAGE STORMWATER RUNOFF ALL OF WHICH WILL REDUCE OFF SITE DISCHARGE OF POLLUTANTS.

PLANNING CRITERIA: THE GRADING PLAN AND INSTALLATION SHALL BE BASED UPON ADEQUATE TOPOGRAPHIC SURVEYS AND INVESTIGATIONS. THE PLAN IS TO SHOW THE LOCATION, SLOPE, CUT, FILL AND FINISH ELEVATION OF THE SURFACES TO BE GRADED. THE PLAN SHOULD ALSO INCLUDE AUXILIARY PRACTICES FOR SAFE DISPOSAL OF RUNOFF WATER, SLOPE STABILIZATION, EROSION CONTROL AND DRAINAGE. FACILITIES SUCH AS WATERWAYS, DITCHES, DIVERSIONS, GRADE STABILIZATION STRUCTURES, RETAINING WALLS AND SUBSURFACE DRAINS SHOULD BE INCLUDED WHERE NECESSARY

EROSION CONTROL MEASURES SHALL BE DESIGNED AND INSTALLED IN ACCORDANCE WITH THE APPLICABLE STANDARD CONTAINED HEREIN.

THE DEVELOPMENT AND ESTABLISHMENT OF THE PLAN SHALL INCLUDE THE FOLLOWING:

- 1. THE CUT FACE OF EARTH EXCAVATIONS AND FILLS SHALL BE NO STEEPER THAN THE SAFE ANGLE OF REPOSE FOR THE MATERIALS ENCOUNTERED AND FLAT ENOUGH FOR PROPER MAINTENANCE.
- THE PERMANENTLY EXPOSED FACES OF EARTH CUTS AND FILLS SHALL BE VEGETATED OR OTHERWISE PROTECTED FROM EROSION.
- PROVISIONS SHALL BE MADE TO SAFELY CONDUCT SURFACE WATER TO STORM DRAINS OR SUITABLE WATER COURSES AND TO PREVENT SURFACE RUNOFF FROM DAMAGING CUT FACES AND FILL SLOPES. SUBSURFACE DRAINAGE IS TO BE PROVIDED IN AREAS HAVING A HIGH WATER TABLE, TO INTERCEPT SEEPAGE THAT WOULD ADVERSELY
- AFFECT SLOPE STABILITY, BUILDING FOUNDATIONS OR CREATE UNDESIRABLE WETNESS. SEE STANDARD FOR SUBSURFACE DRAINAGE, PG 32-1 OF THE SESC MANUAL.
- ADJOINING PROPERTY SHALL BE PROTECTED FROM EXCAVATION AND FILLING OPERATIONS.
- 6. FILL SHALL NOT BE PLACED ADJACENT TO THE BANK OF A STREAM OR CHANNEL, UNLESS PROVISIONS ARE MADE TO PROTECT THE HYDRAULIC, BIOLOGICAL, AESTHETIC AND OTHER ENVIRONMENTAL FUNCTIONS OF THE STREAM.

INSTALLATION REQUIREMENTS:

TIMBER, LOGS, BRUSH, RUBBISH, ROCKS, STUMPS AND VEGETATIVE MATTER WHICH WILL INTERFERE WITH THE GRADING OPERATION OR AFFECT THE PLANNED STABILITY OR FILL AREAS SHALL BE REMOVED AND DISPOSED OF ACCORDING TO THE PLAN.

TOPSOIL IS TO BE STRIPPED AND STOCKPILED IN AMOUNTS NECESSARY TO COMPLETE FINISH GRADING OF ALL EXPOSED AREAS REQUIRING TOPSOIL. SEE STANDARD FOR TOPSOILING, PG. 8-1 OF THE SESC MANUAL

FILL MATERIAL IS TO BE FREE OF BRUSH, RUBBISH, TIMBER, LOGS, VEGETATIVE MATTER AND STUMPS IN AMOUNTS THAT WILL BE DETRIMENTAL TO CONSTRUCTING STABLE FILLS.

ALL FILLS SHALL BE COMPACTED SUFFICIENTLY FOR THEIR INTENDED PURPOSE AND AS REQUIRED TO REDUCE SLIPPING, EROSION OR EXCESSIVE SATURATION.

ALL DISTURBED AREAS SHALL BE LEFT WITH A NEAT AND FINISHED APPEARANCE AND SHALL BE PROTECTED FROM EROSION. SEE STANDARDS FOR PERMANENT VEGETATIVE COVER FOR SOIL STABILIZATION, PG. 4-1 OF THE SESC MANUAL.

TREES TO BE RETAINED SHALL BE PROTECTED IF NECESSARY IN ACCORDANCE WITH THE STANDARD FOR TREE PROTECTION DURING CONSTRUCTION, PG 9-1 OF THE SESC MANUAL.

SOIL COMPACTION RESULTING FROM LAND GRADING ACTIVITIES CAN IMPACT THE INFILTRATION RATE OF THE SOIL. RESTORATION OF COMPACTED SOILS THROUGH DEEP TILLAGE (6" TO 12") AND THE ADDITION OF ORGANIC MATTER MAY BE REQUIRED IN PLANNED PERVIOUS AREAS TO ENHANCE THE INFILTRATION RATE OF THE DISTURBED SOIL. THIS PRACTICE IS PERMISSIBLE ONLY WHERE THERE IS NO DANGER TO UNDERGROUND UTILITIES (CABLES, IRRIGATION SYSTEMS, ETC.

STANDARD FOR DUST CONTROL:

DEFINITION:

THE CONTROL OF DUST ON CONSTRUCTION SITES AND ROADS.

PURPOSE:

TO PREVENT BLOWING AND MOVEMENT OF DUST FROM EXPOSED SOIL SURFACES, REDUCE ON-SITE AND OFF-SITE DAMAGE AND HEALTH HAZARDS AND IMPROVE TRAFFIC SAFETY.

CONDITION WHERE PRACTICE APPLIES:

THIS PRACTICE IS APPLICABLE TO AREAS SUBJECT TO DUST BLOWING AND MOVEMENT WHERE ON-SITE AND OFF-SITE DAMAGE IS LIKELY WITHOUT TREATMENT. CONSULT WITH LOCAL MUNICIPAL ORDINANCES ON ANY RESTRICTIONS.

WATER QUALITY ENHANCEMENT:

SEDIMENTS DEPOSITED AS "DUST" ARE OFTEN FINE COLLOIDAL MATERIAL WHICH IS EXTREMELY DIFFICULT TO REMOVE FROM WATER ONCE IT BECOMES SUSPENDED. USE OF THIS STANDARD WILL HELP TO CONTROL THE GENERATION OF DUST FROM CONSTRUCTION SITES AND SUBSEQUENT BLOWING AND DEPOSITION INTO LOCAL SURFACE WATER RESOURCES.

PLANNING CRITERIA:

THE FOLLOWING METHODS SHOULD BE CONSIDERED FOR CONTROLLING DUST:

• MULCHES •

VEGETATIVE COVER

• SPRAY-ON ADHESIVES - ON MINERAL SOILS (NOT EFFECTIVE ON MUCK SOILS). KEEP TRAFFIC OFF THESE AREAS.

DUST CONTROL MATERIALS

MATERIAL	WATER	TYPE OF	APPLY
	DILUTION	NOZZLE	GALLONS/ACRE
ANIONIC ASPHALT EMULSION	7:1	COARSE SPRAY	1200
LATEX EMULSION	12.5:1	FINE SPRAY	235
RESIN IN WATER	4:1	FINE SPRAY	300
POLYACRYLAMIDE (PAM) - SPRAY ON	APPLY ACCORDING	TO MANUFACTURER'S	INSTRUCTIONS.
POLYACRYLAMIDE (PAM) - DRY SPREAD	MAY ALSO BE USED) AS AN ADDITIVE TO) SEDIMENT BASINS
	TO FLOCCULATE AN	D PRECIPITATE SUSP	ENDED COLLOIDS.
RESIN IN WATER	NONE	COARSE SPRAY	1200

TILLAGE:

TO ROUGHEN SURFACE AND BRING CLODS TO THE SURFACE. THIS IS A TEMPORARY EMERGENCY MEASURE WHICH SHOULD BE USED BEFORE SOIL BLOWING STARTS. BEGIN PLOWING ON WINDWARD SIDE OF SITE. CHISEL-TYPE PLOWS SPACED ABOUT 12 INCHES APART AND SPRING-TOOTHED HARROWS ARE EXAMPLES OF EQUIPMENT WHICH MAY PRODUCE THE DESIRED EFFECT.

<u>SPRINKLING:</u>

SITE IS SPRINKLED UNTIL THE SURFACE IS WET.

BARRIERS:

SOLID BOARD FENCES, SNOW FENCES, BURLAP FENCES, CRATE WALLS, BALES OF HAY AND SIMILAR MATERIAL CAN BE USED TO CONTROL AIR CURRENTS AND SOIL BLOWING.

CALCIUM CHLORIDE:

SHALL BE IN THE FORM OF LOOSE. DRY GRANULES OR FLAKES FINE ENOUGH TO FEED THROUGH COMMONLY USED SPREADERS AT A RATE THAT WILL KEEP SURFACE MOIST BUT NOT CAUSE POLLUTION OR PLANT DAMAGE. IF USED ON STEEPER SLOPES, THEN USE OTHER PRACTICES TO PREVENT WASHING INTO STREAMS OR ACCUMULATION AROUND PLANTS.

STONE: COVER SURFACE WITH CRUSHED STONE OR COARSE GRAVEL. STANDARD FOR TEMPORARY VEGETATIVE COVER FOR SOIL STABILIZATION:

ESTABLISHMENT OF TEMPORARY VEGETATIVE COVER ON SOILS EXPOSED FOR PERIODS OF TWO TO 6 MONTHS WHICH ARE NOT BEING GRADED, NOT UNDER ACTIVE CONSTRUCTION OR NOT SCHEDULED FOR PERMANENT SEEDING WITHIN 60 DAYS.

TO TEMPORARILY STABILIZE THE SOIL AND REDUCE DAMAGE FROM WIND AND WATER EROSION UNTIL PERMANENT STABILIZATION IS ACCOMPLISHED.

WATER QUALITY ENHANCEMENT: PROVIDES TEMPORARY PROTECTION AGAINST THE IMPACTS OF WIND AND RAIN, SLOWS THE OVER LAND MOVEMENT OF STORMWATER RUNOFF, INCREASES INFILTRATION AND RETAINS SOIL AND NUTRIENTS ON SITE, PROTECTING STREAMS OR OTHER STORMWATER CONVEYANCES.

WHERE APPLICABLE: ON EXPOSED SOILS THAT HAVE THE POTENTIAL FOR CAUSING OFF-SITE ENVIRONMENTAL DAMAGE.

- STANDARD FOR TEMPORARY STABILIZATION WITH MULCH A. MULCHING IS MOST APPLICABLE TO THOSE AREAS SUBJECT TO PERIODIC DISTURBANCE AND REWORKING. IN ADDITION, STABILIZATION WITH MULCH SHALL BE USED DURING NON-GERMINATION PERIODS.
- B. PERFORM ALL CULTURAL OPERATIONS AT RIGHT ANGLES TO THE SLOPE.
- C. PROTECTIVE MATERIALS TO BE USED: C.A. UNROTTED SMALL-GRAIN STRAW OR HAY AT 3.0 TONS PER ACRE SPREAD UNIFORMLY AT 135 POUNDS PER 1000 SQUARE FEET AND ANCHORED WITH LIQUID MULCH BINDER OR; WOOD-FIBER OR PAPER-FIBER MULCH AT A RATE OF 1500 POUNDS
- PER ACRE MAY BE APPLIED BY A HYDROSEEDER OR HYDROMULCHER. USE IS LIMITED TO FLATTER SLOPES AND DURING OPTIMUM SEEDING PERIODS IN SPRING AND FALL. C.B. LIQUID MULCH BINDERS: APPLY IMMEDIATELY AFTER PLACEMENT OF HAY OR STRAW MULCH TO MINIMIZE LOSS BY WIND OR WATER. IF EMULSIFIED ASPHALT - (SS-1, CSS-1, CMS-2, MS-2, RS-1, RS-2, CRS-1 AND CRS-2), APPLY 0.04 GAL./SQ. YD. OR 194 GAL./ACRE ON FLAT SLOPES LESS THAN 8' HIGH. ON SLOPES 8' OR MORE HIGH USE 0.075 GAL./SQ. YD. OR 363 GAL./ACRE.

STANDARD FOR TEMPORARY STABILIZATION WITH SEED

- SITE PREPARATION: A. APPLY 1 TON OF AGRICULTURAL-GRADE LIMESTONE PER ACRE
- B. FERTILIZER AT THE RATE OF 50-50-50 PER ACRE C. WORK LIME AND FERTILIZER INTO THE SOIL AS NEARLY AS PRACTICAL TO A DEPTH OF FOUR (4) INCHES.
- TEMPORARY SEEDING:
- A. SECURE A SOIL TEST BEFORE MAKING A PERMANENT SEEDING.
- B. APPLY TEMPORARY SEEDING: WINTER RYE: SHALL BE APPLIED AT A RATE OF 168 LB/ACRE (56% PLS) C. AFTER SEEDING, MULCH WITH HAY OR STRAW (SEE MULCH SPECIFICATIONS) AT A RATE OF 3 TONS PER ACRE

STANDARD FOR PERMANENT VEGETATIVE COVER FOR SOIL STABILIZATION:

ESTABLISHMENT OF PERMANENT VEGETATIVE COVER ON EXPOSED SOILS WHERE PERENNIAL VEGETATION IS NEEDED FOR LONG-TERM PROTECTION.

TO PERMANENTLY STABILIZE THE SOIL, ENSURING CONSERVATION OF SOIL AND WATER, AND TO ENHANCE THE ENVIRONMENT.

WATER QUALITY ENHANCEMENT: SLOWS THE OVER-LAND MOVEMENT OF STORMWATER RUNOFF, INCREASES INFILTRATION AND RETAINS SOIL AND NUTRIENTS ON SITE, PROTECTING STREAMS OR OTHER STORMWATER CONVEYANCES.

<u>WHERE APPLICABLE</u>

ON EXPOSED SOILS THAT HAVE A POTENTIAL FOR CAUSING OFF-SITE ENVIRONMENTAL DAMAGE

SITE PREPARATION:

- A. GRADE AS NEEDED AND FEASIBLE TO PERMIT THE USE OF CONVENTIONAL EQUIPMENT FOR SEEDBED PREPARATION, SEEDING, MULCH APPLICATION, AND MULCH ANCHORING. ALL GRADING SHOULD BE DONE IN ACCORDANCE WITH STANDARD FOR LAND GRADING. B. IMMEDIATELY PRIOR TO SEEDING AND TOPSOIL APPLICATION, THE SUBSOIL SHALL BE EVALUATED FOR COMPACTION IN ACCORDANCE WITH THE STANDARD FOR LAND GRADING.
- C. TOPSOIL SHOULD BE HANDLED ONLY WHEN IT IS DRY ENOUGH TO WORK WITHOUT DAMAGING THE SOIL STRUCTURE. A UNIFORM APPLICATION TO A DEPTH OF 5 INCHES (UNSETTLED) IS REQUIRED ON ALL SITES. TOPSOIL SHALL BE AMENDED WITH ORGANIC MATTER. AS NEEDED. IN ACCORDANCE WITH THE STANDARD FOR TOPSOILING.
- D. INSTALL NEEDED EROSION CONTROL PRACTICES OR FACILITIES SUCH AS DIVERSIONS, GRADE-STABILIZATION STRUCTURES, CHANNEL STABILIZATION MEASURES, SEDIMENT BASINS, AND WATERWAYS.

PERMANENT SEEDING SHALL CONSIST OF THE FOLLOWING MIXTURES OR APPROVED EQUAL- SEEDING IS NOT PERMITTED BETWEEN OCTOBER 2ND AND MARCH 14TH.

KENTUCKY BLUE GRASS- 1.0 LBS/1,000 S.F. TURF-TYPE TALL FESCUE- 5.0 LBS/1,000 S.F.

MULCHING IS REQUIRED ON ALL SEEDING. MULCH WILL PROTECT AGAINST EROSION BEFORE GRASS IS ESTABLISHED AND WILL PROMOTE FASTER AND EARLIER ESTABLISHMENT. THE EXISTENCE OF VEGETATION SUFFICIENT TO CONTROL SOIL EROSION SHALL BE DEEMED COMPLIANCE WITH THIS MULCHING REQUIREMENT.

PRIOR TO ANY EARTH DISTURBANCE. (DEMOLITION):

DURATION: 6 MONTHS CONSTRUCTION SEQUENCE:

- 1. INSTALL STABILIZED CONSTRUCTION EXIT(S).

- 10. PAVE ROADWAYS.

PROTECTION IS ESTABLISHED.

4. SEDIMENT FENCES ARE TO BE PROPERLY TRENCHED AND MAINTAINED UNTIL PERMANENT VEGETATIVE COVER IS ESTABLISHED 5. ALL STORM DRAINAGE INLETS SHALL BE PROTECTED BY ONE OF THE PRACTICES ACCEPTED IN THE STANDARDS, AND PROTECTION SHALL REMAIN UNTIL PERMANENT STABILIZATION HAS BEEN ESTABLISHED. STORM DRAINAGE OUTLET POINTS SHALL BE

6. MULCH MATERIALS SHALL BE UN-ROTTED SMALL GRAIN STRAW APPLIED AT THE RATE OF 70 TO 90 POUNDS PER 1,000 SQUARE FEET AND ANCHORED WITH A MULCH ANCHORING TOOL, LIQUID MULCH BINDERS, OR NETTING TIE DOWN. OTHER SUITABLE MATERIALS MAY BE USED IF APPROVED BY THE SOIL CONSERVATION DISTRICT.

7. ALL EROSION CONTROL DEVICES SHALL BE PERIODICALLY INSPECTED, MAINTAINED AND CORRECTED BY THE CONTRACTOR. ANY DAMAGE INCURRED BY EROSION SHALL BE RECTIFIED IMMEDIATELY.

8. THE HUDSON-ESSEX-PASSAIC SOIL CONSERVATION DISTRICT WILL BE NOTIFIED IN WRITING AT LEAST 48 HOURS PRIOR TO ANY SOIL DISTURBING ACTIVITIES. FAX - (862) 333-4507 OR EMAIL - INFORMATION@HEPSCD.ORG

13. A CRUSHED STONE WHEEL CLEANING TRACKING-PAD IS TO BE INSTALLED AT ALL SITE EXITS USING 2 1/2 -1"CRUSHED ANGULAR STONE (ASTM 2 OR 3) TO A MINIMUM LENGTH OF 50 FEET AND MINIMUM DEPTH OF 6". ALL DRIVEWAYS MUST BE PROVIDED WITH CRUSHED STONE UNTIL PAVING IS COMPLETE.

15. THE HUDSON-ESSEX-PASSAIC SOIL CONSERVATION DISTRICT SHALL BE NOTIFIED, IN WRITING, FOR THE SALE OF ANY PORTION OF THE PROJECT OR FOR THE SALE OF INDIVIDUAL LOTS. NEW OWNERS' INFORMATION SHALL BE PROVIDED. ADDITIONAL MEASURES DEEMED NECESSARY BY DISTRICT OFFICIALS SHALL BE IMPLEMENTED AS CONDITIONS WARRANT.

SEQUENCE OF CONSTRUCTION:

THERE SHALL BE AN ON-SITE PRE-CONSTRUCTION MEETING WITH REPRESENTATIVES FROM THE COUNTY CONSERVATION DISTRICT, CONTRACTOR, AND THE CIVIL ENGINEER. THE CONTRACTOR SHALL NOTIFY THE COUNTY CONSERVATION DISTRICT IN WRITING AT LEAST 48 HOURS PRIOR TO ANY LAND DISTURBANCE/DEMOLITION WORK. THE LIMIT OF DISTURBANCE SHALL BE STAKED AND DELINEATED

2. INSTALL SILT FENCE(S) ON THE SITE (CLEAR ONLY THOSE AREAS NECESSARY TO INSTALL SILT FENCE).

3. INSTALL APPROPRIATE INLET PROTECTION DEVICES PERTINENT TO THE CURRENT LIMITS OF CONSTRUCTION. 3. BEGIN SELECTED DEMOLITION OF EXISTING UTILITIES, AND ANY CURBING/PAVEMENT. LIMIT COMPLETE REMOVAL OF EXISTING

EARTH COVER (ASPHALT, ROAD BASE, VEGETATION) TO THE MAXIMUM EXTENT POSSIBLE. TEMPORARILY SEED, THROUGHOUT CONSTRUCTION, DENUDED AREAS THAT WILL BE INACTIVE FOR 14 DAYS OR MORE. 5. INSTALL AND STABILIZE STORMWATER PIPE NETWORK.

6. INSTALL APPROPRIATE INLET PROTECTION MEASURES AT ALL STORM SEWER STRUCTURES AS EACH INLET STRUCTURE IS INSTALLED. INLET PROTECTION MEASURES ARE TO BE MODIFIED AS NECESSARY TO MATCH CHANGES IN SITE CONDITIONS DURING CONSTRUCTION.

7. BEGIN CLEARING AND GRUBBING THE SITE IN THOSE AREAS PERTINENT TO THE CURRENT LIMITS OF CONSTRUCTION. CLEAR ONLY THOSE AREAS NECESSARY TO ESTABLISH THE PROPOSED FINISHED GRADE AND CONSTRUCT THE PROPOSED IMPROVEMENTS WITHIN THE CURRENT LIMITS OF DISTURBANCE.

8. TEMPORARILY SEED, THROUGHOUT CONSTRUCTION, DENUDED AREAS THAT WILL BE INACTIVE FOR 14 DAYS OR MORE. 9. BEGIN GRADING THE SITE WITHIN THE CURRENT LIMITS OF DISTURBANCE. ALL AREAS AT FINAL GRADE MUST BE PERMANENTLY STABILIZED IMMEDIATELY AFTER COMPLETION OF WORK IN THAT AREA.

11. INSTALL APPROPRIATE INLET PROTECTION DEVICES FOR PAVED AREAS AS WORK PROGRESSES 12. UPON COMPLETION OF ALL EARTH DISTURBANCE ACTIVITIES AND PERMANENT STABILIZATION OF ALL DISTURBED AREAS, THE GENERAL CONTRACTOR IS TO CONTACT A REPRESENTATIVE FROM THE LOCAL CONSERVATION DISTRICT SCHEDULE A SITE INSPECTION PRIOR TO REMOVAL OF THE EROSION AND SEDIMENTATION CONTROL BMP'S.

13. OBTAIN CONCURRENCE WITH THE LOCAL CONSERVATION DISTRICT THAT FINAL SITE STABILIZATION HAS BEEN ACHIEVED. 14. REMOVE ALL TEMPORARY EROSION AND SEDIMENT CONTROL DEVICES. 15. STABILIZE ANY AREAS DISTURBED BY THE REMOVAL OF EROSION AND SEDIMENT CONTROL DEVICES.

16. CONTACT THE LOCAL CONSERVATION DISTRICT AT 862-333-4505 TO REQUEST A FINAL INSPECTION, GIVING ADVANCED NOTICE UPON COMPLETION OF THE RESTABILIZATION MEASURES. 17. A DISTRICT ISSUED REPORT-OF-COMPLIANCE MUST BE OBTAINED PRIOR TO APPLYING FOR THE CERTIFICATE OF

OCCUPANCY OR TEMPORARY CERTIFICATE OF OCCUPANCY FROM THE RESPECTIVE MUNICIPALITY, NJ - DCA OR ANY OTHER CONTROLLING AGENCY. A PERFORMANCE DEPOSIT MAY BE POSTED WITH THE DISTRICT WHEN WINTER WEATHER OR SNOW COVER PROHIBITS THE PROPER APPLICATION OF SEED, MULCH, FERTILIZER OR HYDRO-SEED.

SEDIMENT AND EROSION CONTROL

(HUDSON-ESSEX-PASSAIC COUNTY) NOTES:

1. ALL SOIL EROSION AND SEDIMENT CONTROL PRACTICES ON THIS PLAN WILL BE CONSTRUCTED IN ACCORDANCE WITH THE 'NEW JERSEY STANDARDS FOR SOIL EROSION AND SEDIMENT CONTROL" 7TH EDITION LAST REVISED JANUARY 2014. THESE MEASURES WILL BE INSTALLED PRIOR TO ANY MAJOR SOIL DISTURBANCE OR IN THEIR PROPER SEQUENCE AND MAINTAINED UNTIL PERMANENT

2. ALL SOIL TO BE EXPOSED OR STOCKPILED FOR A PERIOD OF GREATER THAN 14 DAYS, AND NOT UNDER ACTIVE CONSTRUCTION, WILL BE TEMPORARILY SEEDED AND HAY MULCHED OR OTHERWISE PROVIDED WITH VEGETATIVE COVER. THIS TEMPORARY COVER SHALL BE MAINTAINED UNTIL SUCH TIME WHEREBY PERMANENT RESTABILIZATION IS ESTABLISHED.

3. <u>SEEDING DATES:</u> THE FOLLOWING SEEDING DATES ARE RECOMMENDED TO BEST ESTABLISH PERMANENT VEGETATIVE COVER WITHIN MOST LOCATIONS IN THE HEPSCD: <u>SPRING - 3/1-5/15</u> AND <u>FALL - 8/15 - 10/1</u>

PROTECTED AS REQUIRED BEFORE THEY BECOME FUNCTIONAL.

9. THE APPLICANT MUST OBTAIN A DISTRICT ISSUED REPORT-OF-COMPLIANCE PRIOR TO APPLYING FOR THE CERTIFICATE OF OCCUPANCY OR TEMPORARY CERTIFICATE OF OCCUPANCY FROM THE RESPECTIVE MUNICIPALITY, NJ - DCA OR ANY OTHER CONTROLLING AGENCY. CONTACT THE DISTRICT AT 862-333-4505 TO REQUEST A FINAL INSPECTION. GIVING ADVANCED NOTICE UPON COMPLETION OF THE RESTABILIZATION MEASURES. A PERFORMANCE DEPOSIT MAY BE POSTED WITH THE DISTRICT WHEN WINTER WEATHER OR SNOW COVER PROHIBITS THE PROPER APPLICATION OF SEED. MULCH. FERTILIZER OR HYDRO-SEED.

10. PAVED ROADWAYS MUST BE KEPT CLEAN AT ALL TIMES. DO NOT UTILIZE A FIRE OR GARDEN HOSE TO CLEAN ROADS UNLESS THE RUNOFF IS DIRECTED TO A PROPERLY DESIGNED AND FUNCTIONING SEDIMENT BASIN. WATER PUMPED OUT OF THE EXCAVATED AREAS CONTAINS SEDIMENTS THAT MUST BE REMOVED PRIOR TO DISCHARGING TO RECEIVING BODIES OF WATER USING REMOVABLE PUMPING STATIONS. SUMP PITS. PORTABLE SEDIMENTATION TANKS AND/OR SILT CONTROL BAGS.

11. ALL SURFACES HAVING LAWN OR LANDSCAPING AS FINAL COVER ARE TO BE PROVIDED TOPSOIL PRIOR TO RE-SEEDING. SODDING OR PLANTING. A DEPTH OF 5 INCHES (UNSETTLED) IS RECOMMENDED.

12. ALL PLAN REVISIONS MUST BE SUBMITTED TO THE DISTRICT FOR PROPER REVIEW AND APPROVAL.

14. STEEP SLOPES INCURRING DISTURBANCE MAY REQUIRE ADDITIONAL STABILIZATION MEASURES. THESE "SPECIAL" MEASURES SHALL BE DESIGNED BY THE APPLICANT'S ENGINEER AND BE APPROVED BY THE SOIL CONSERVATION DISTRICT.

92 East Main Street, Suite 410 Somerville, NJ 08876 t: 732-537-0811





07/21/2020 PLANNING BOARD SUBMISSION

07/07/2020 BID SET

PROFESSIONAL SEAL FNEW



PROFESSIONAL IN CHARGE **STEPHEN POWERS** PROFESSIONAL ENGINEER LICENSE NO. 24GE04773100 **PROJECT MANAGER** RICHARD PROCANIK QUALITY CONTROL RICHARD PROCANIK DRAWN BY THOMAS WIENCKOWSKI

PROJECT NAME **111 IDEATION WAY** PARKING LO1

NUTLEY **NEW JERSEY**


EXISTING BLOCK 300 LOT 1 & 1.05 PROPOSED LOT 1.05A TOWNSHIP OF NUTLEY ESSEX COUNTY, NJ ZONING DISTRICT: RRP-2A ROCHE REDEVELOPMENT PLAN PHASE IIA


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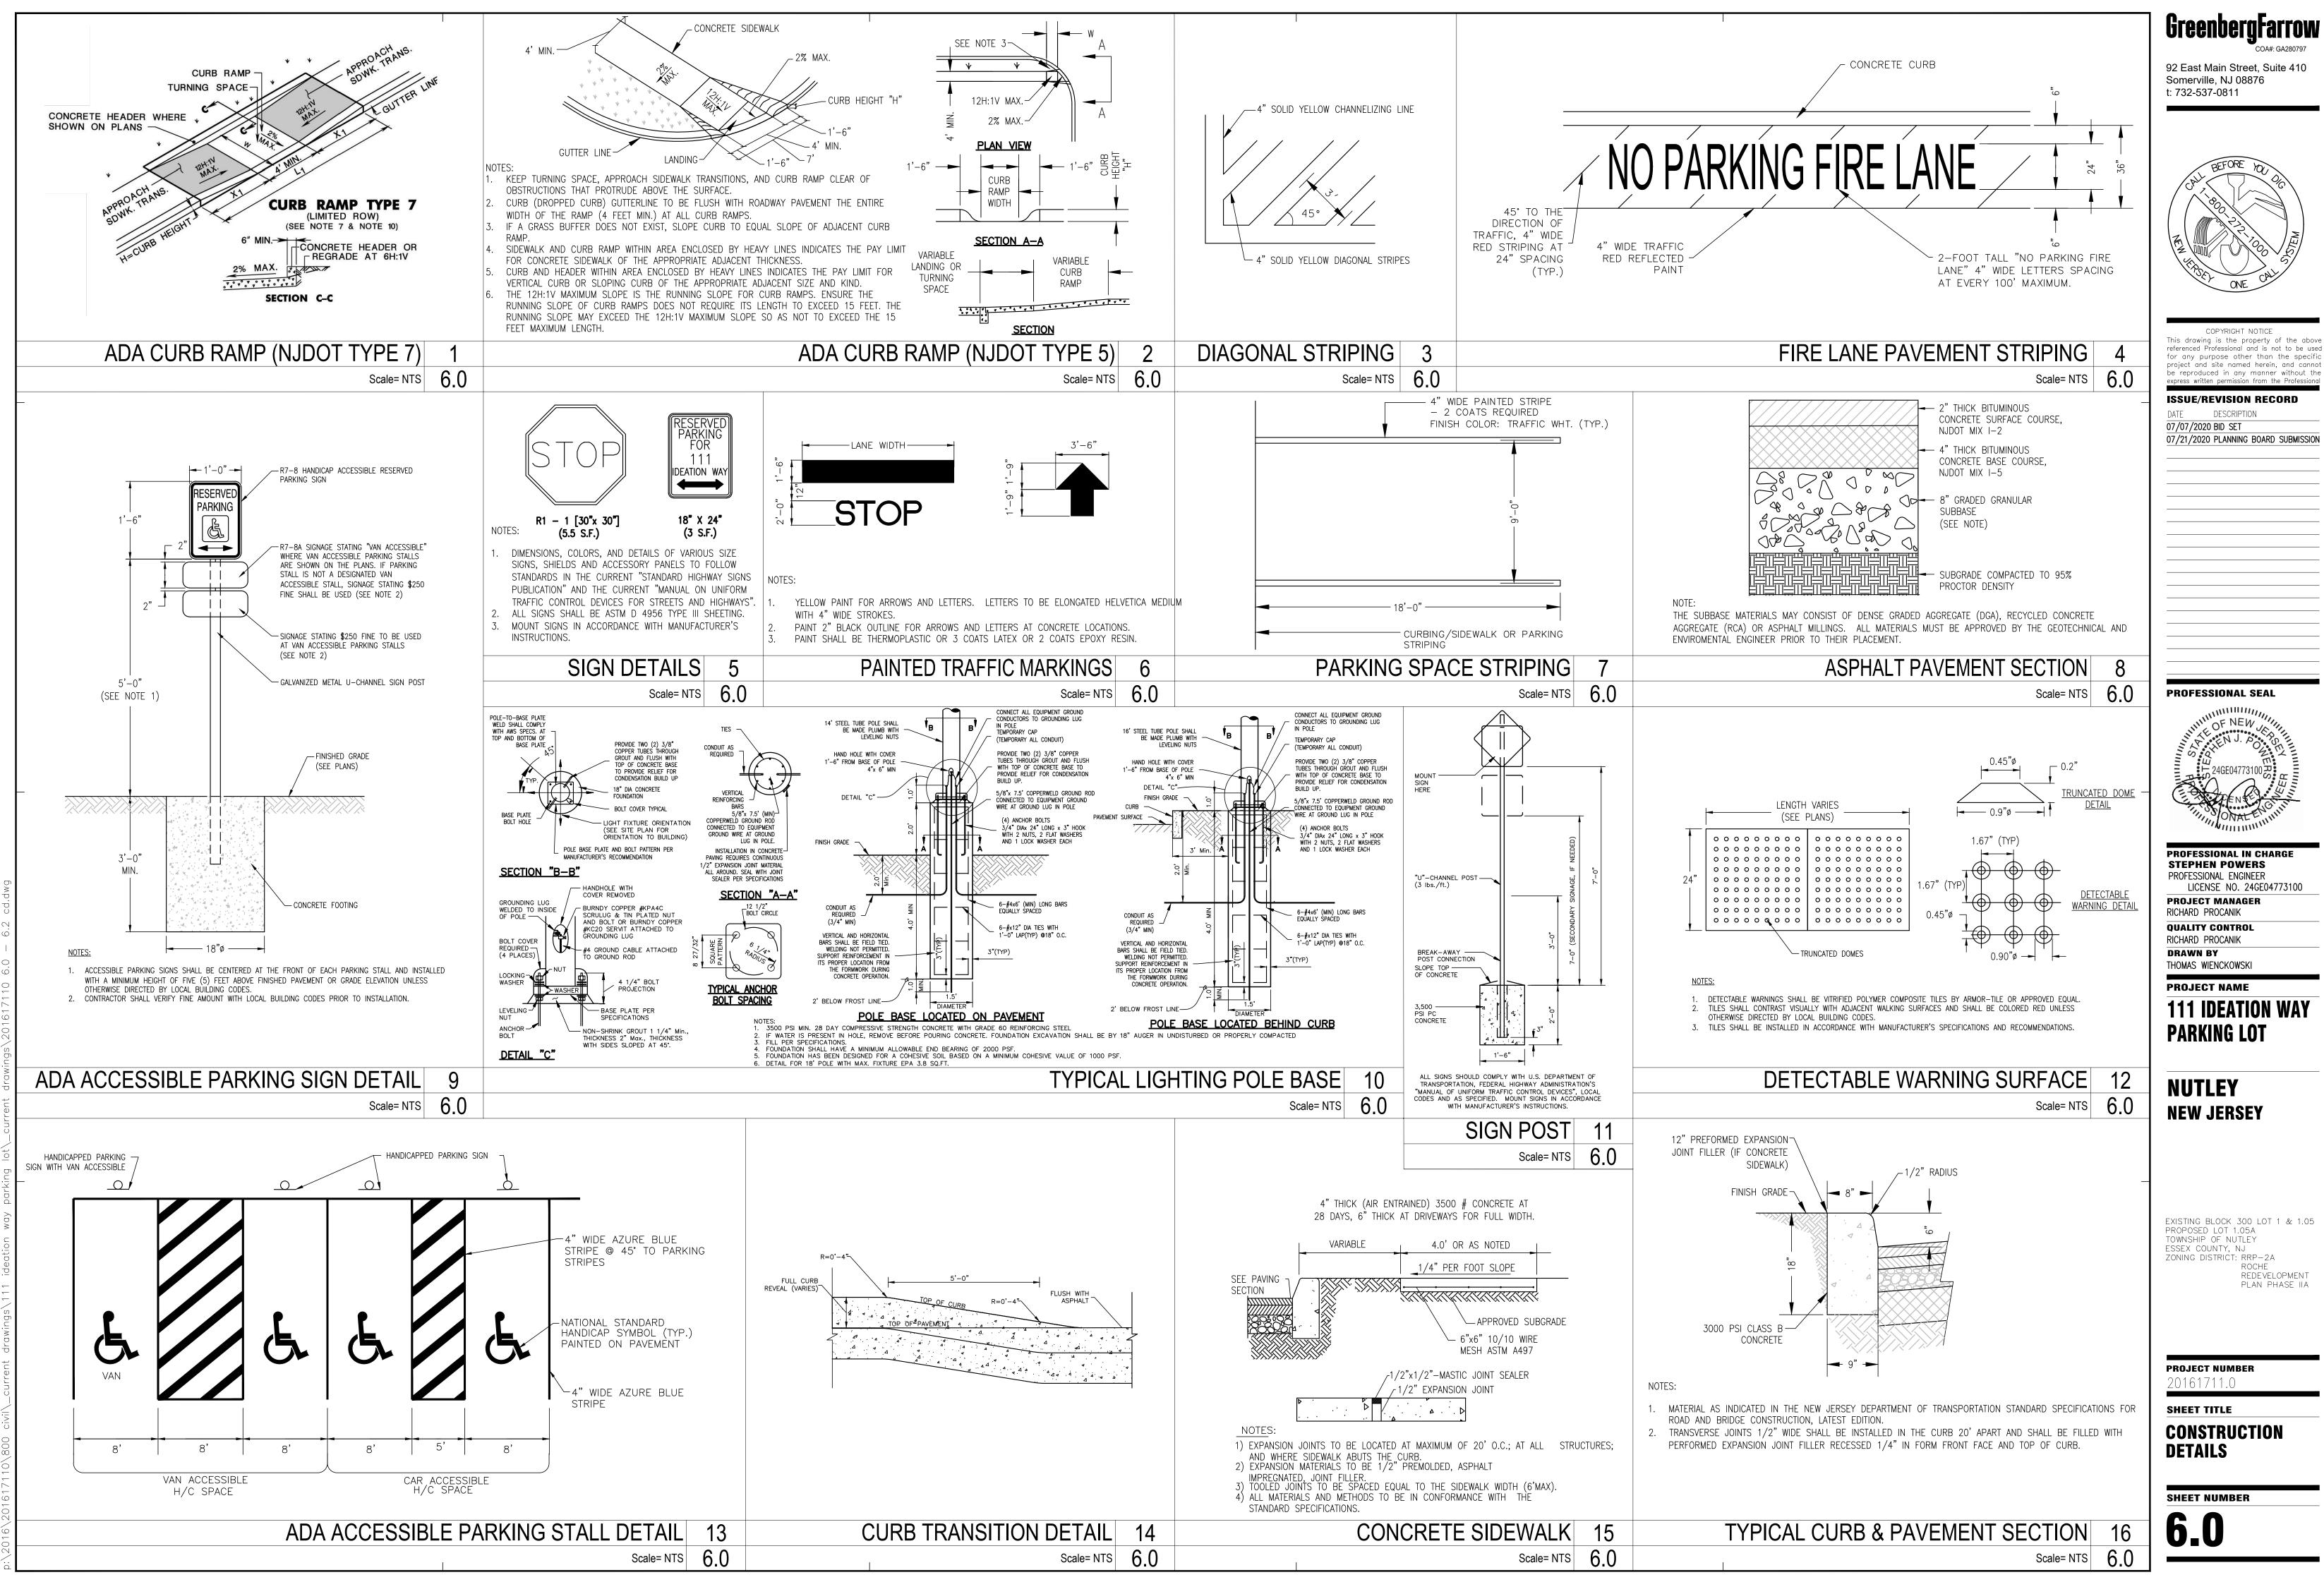
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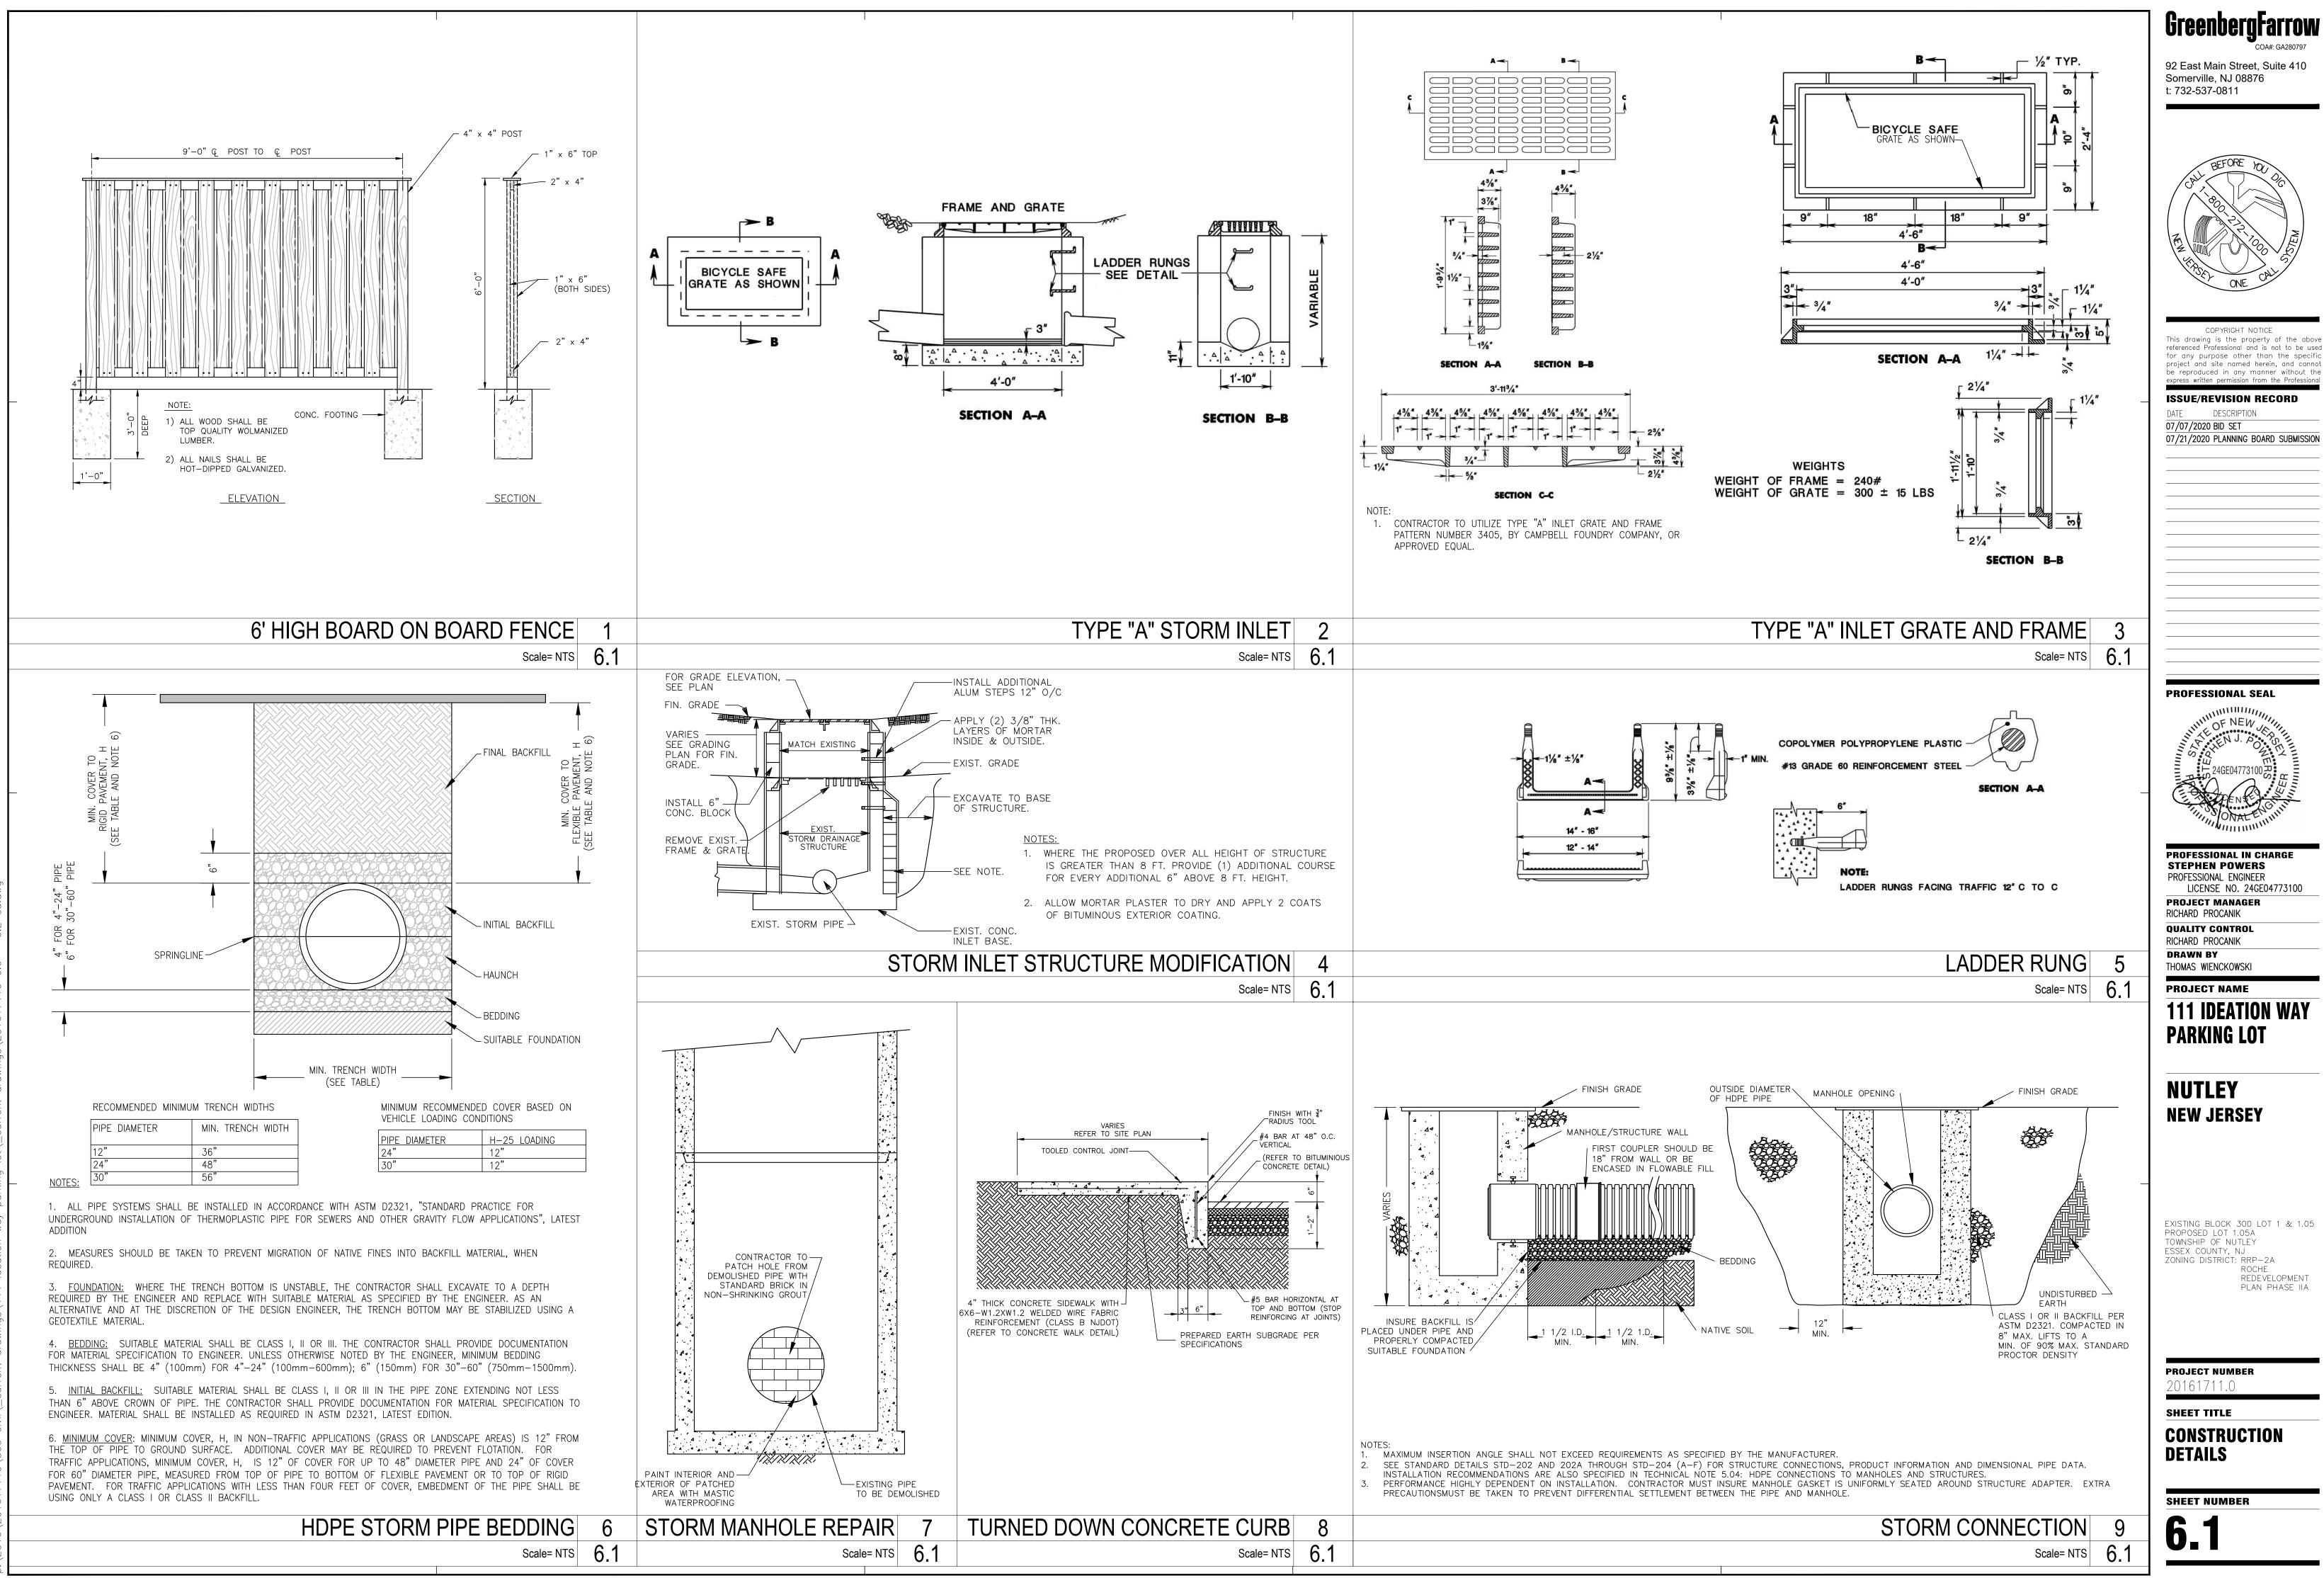
SOIL EROSION AND SEDIMENT CONTROL NOTES


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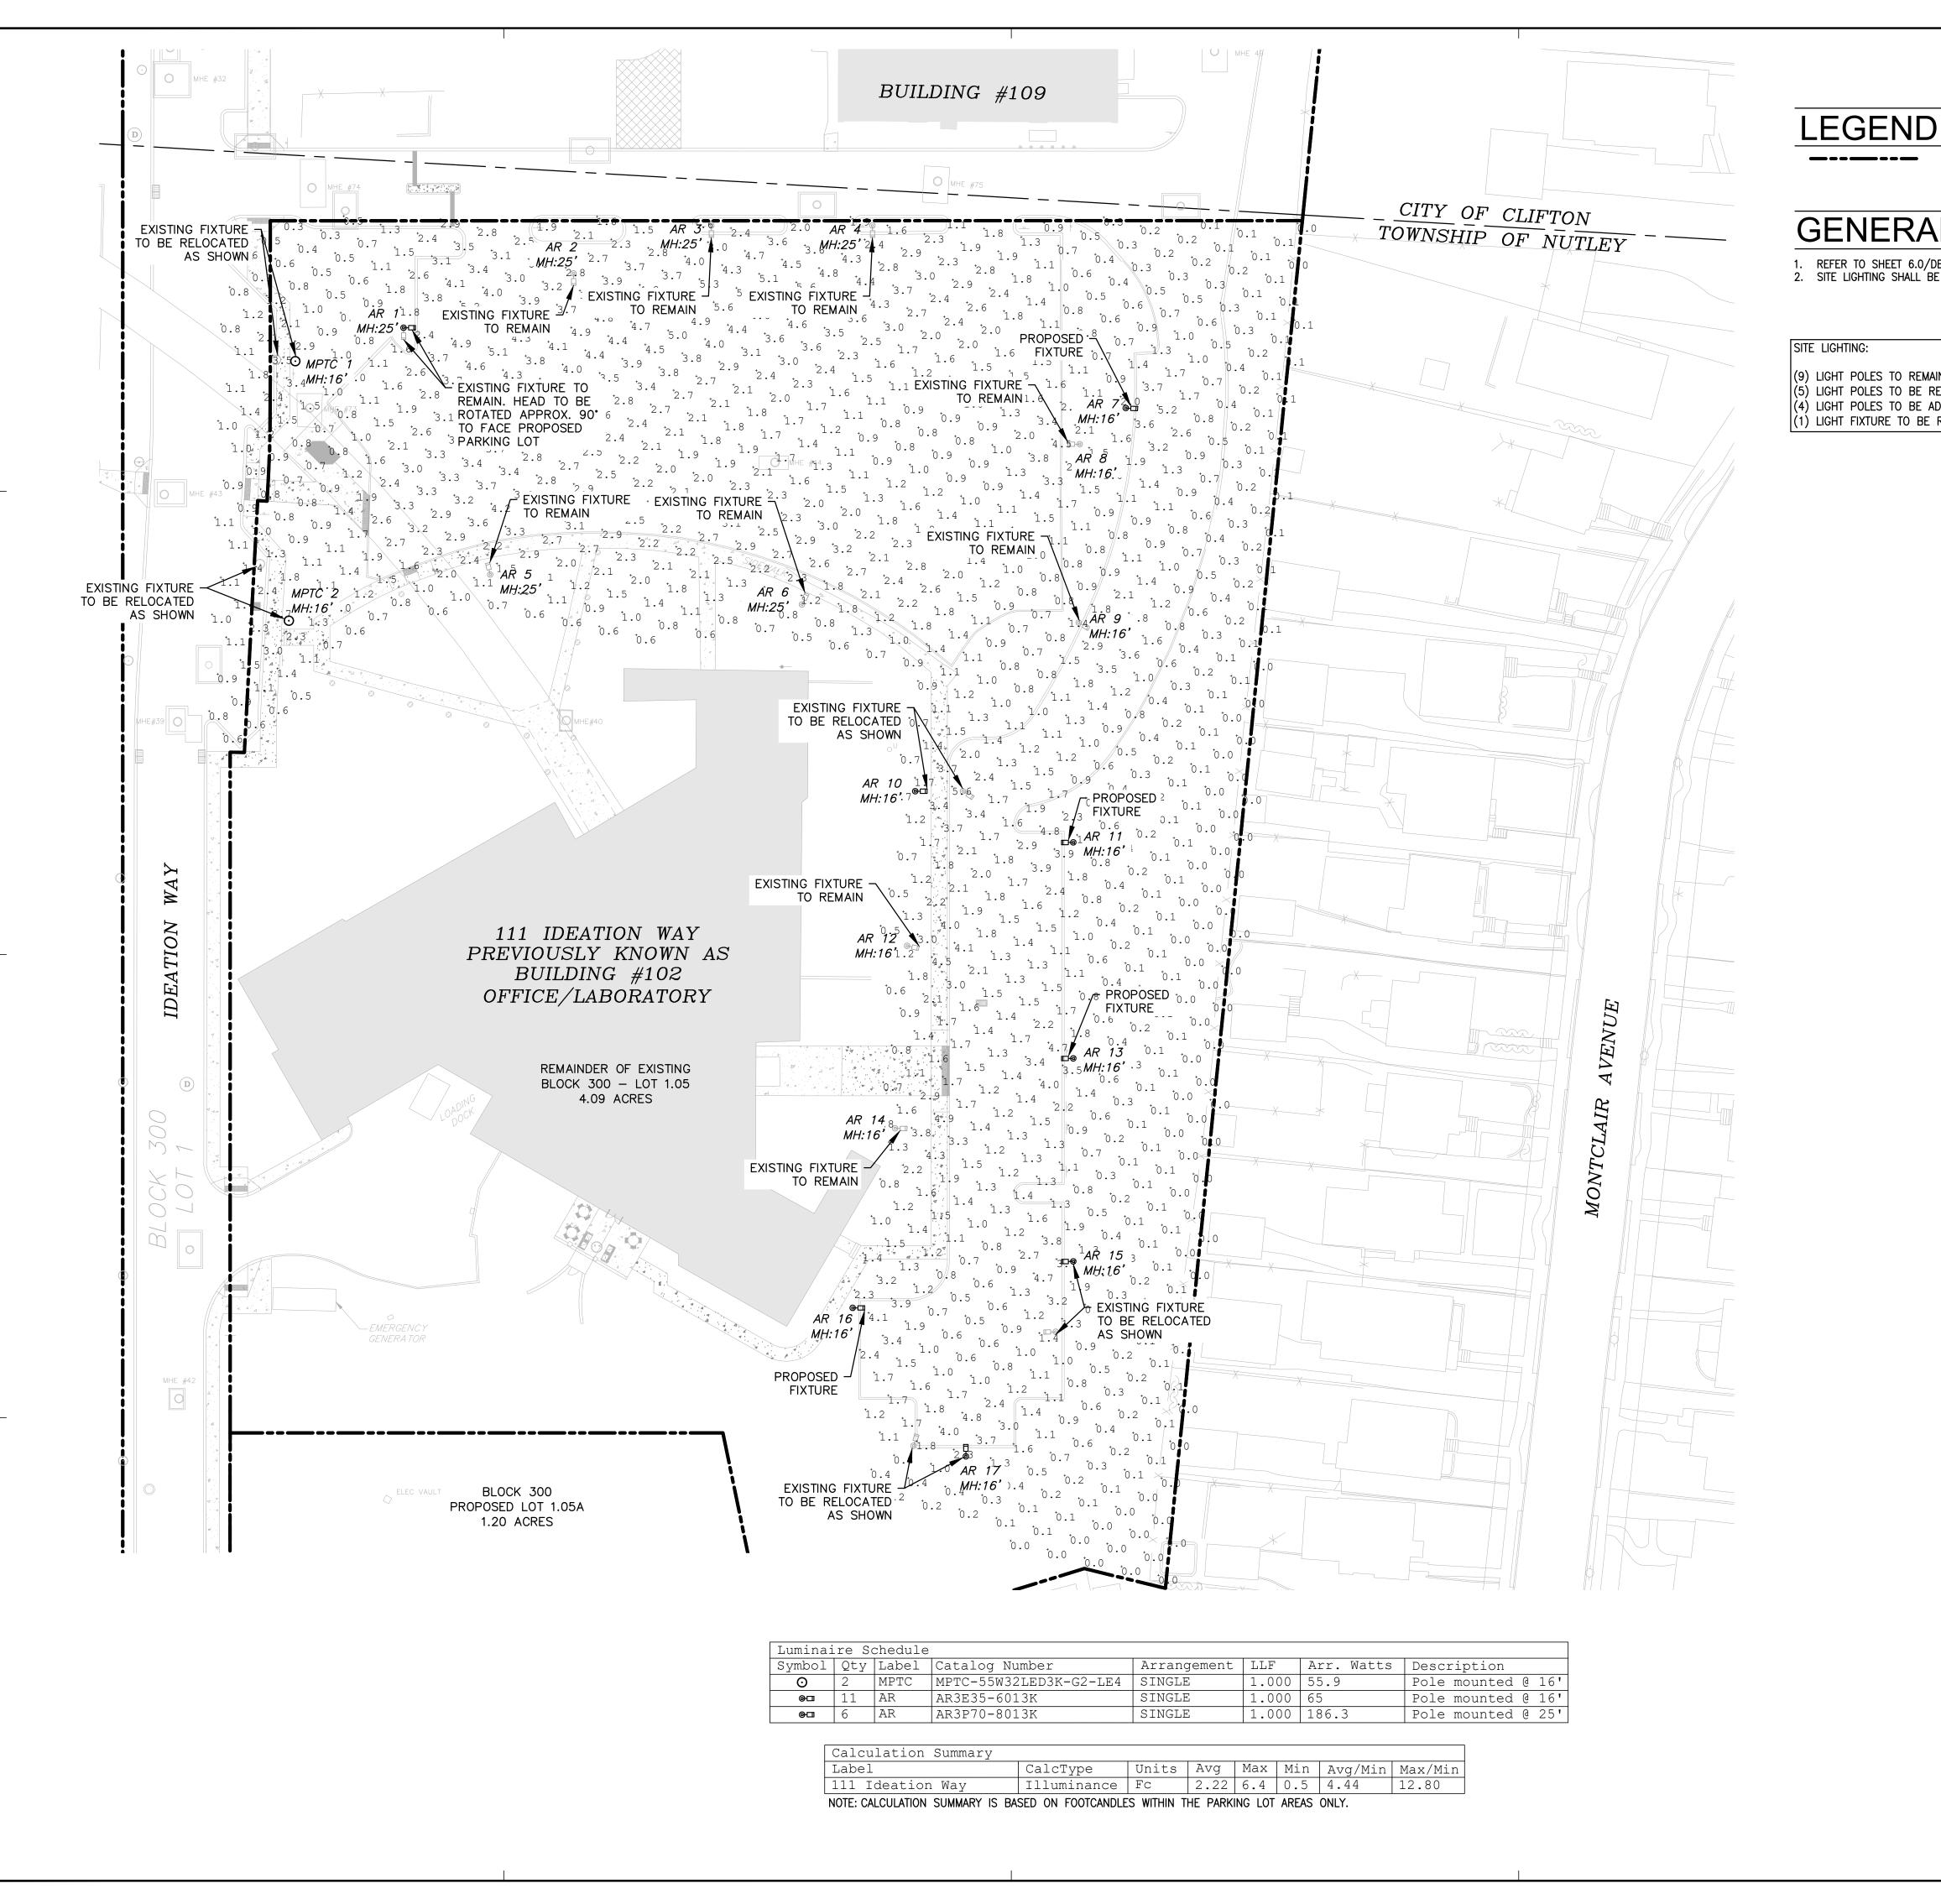






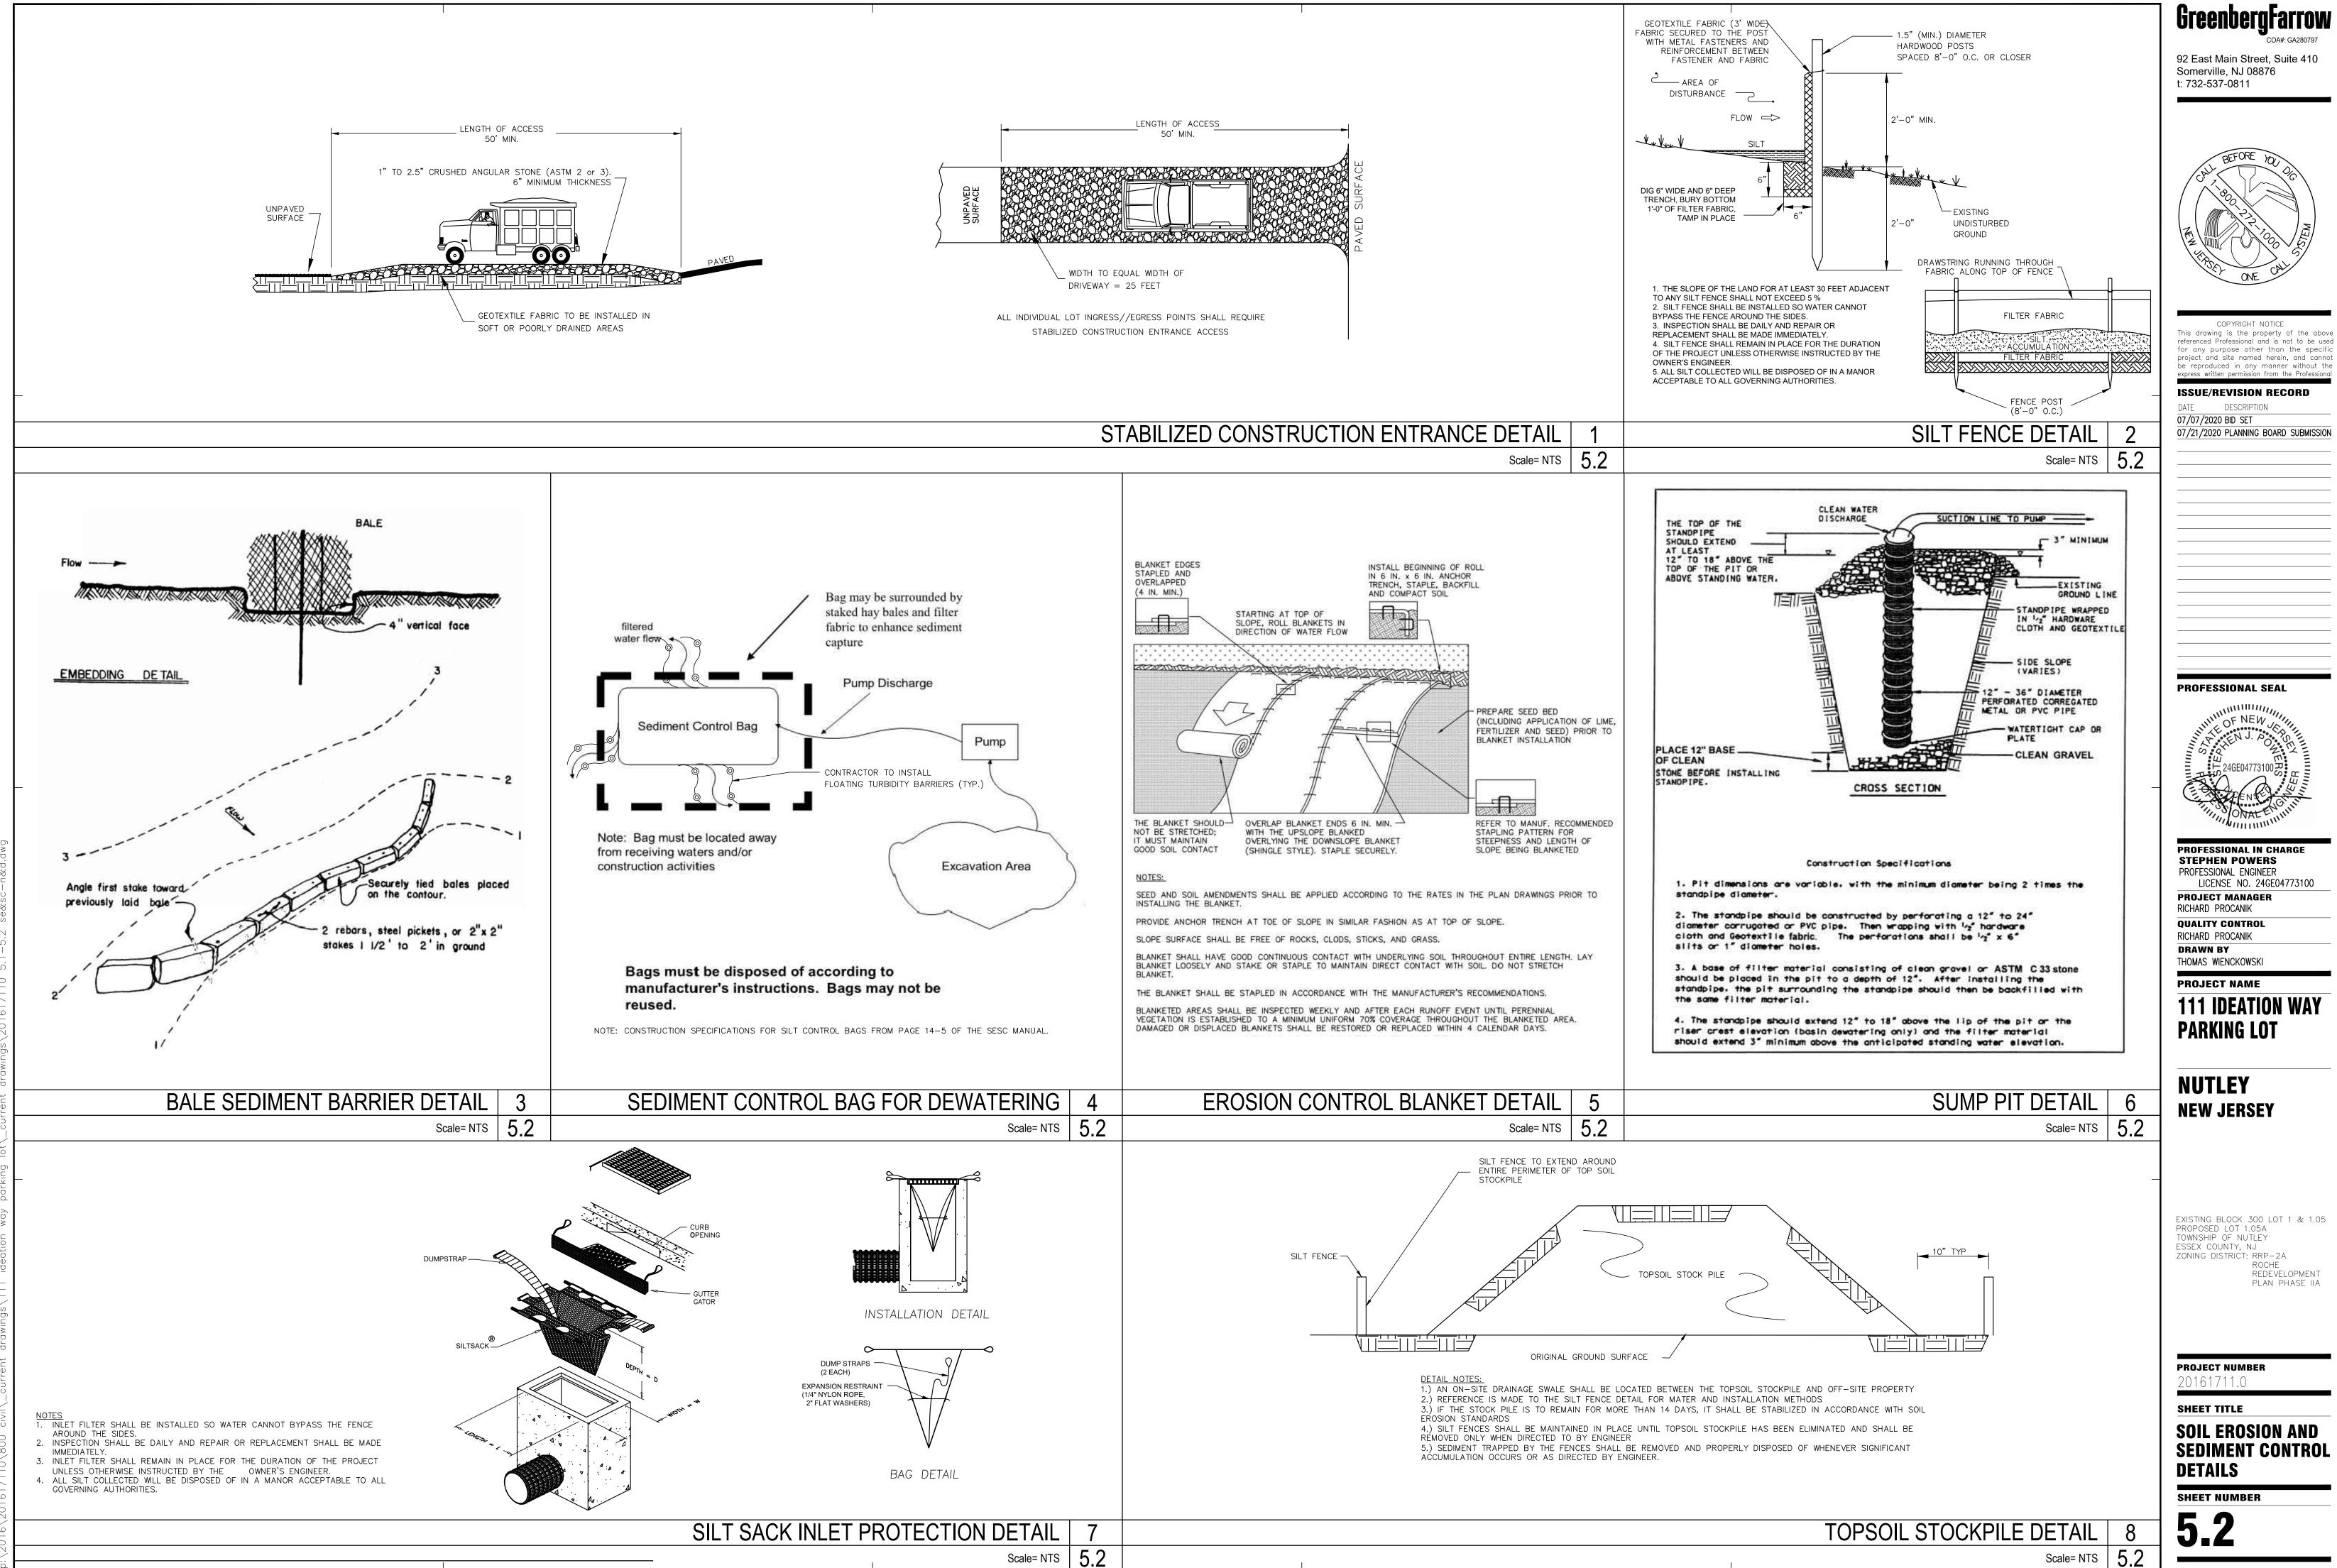

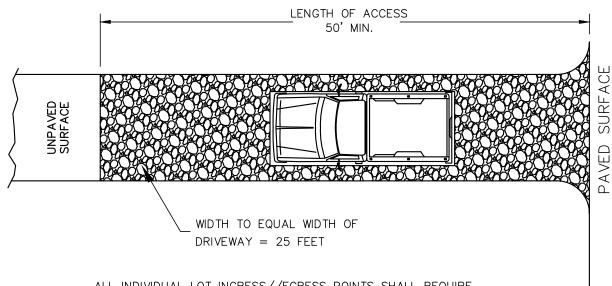

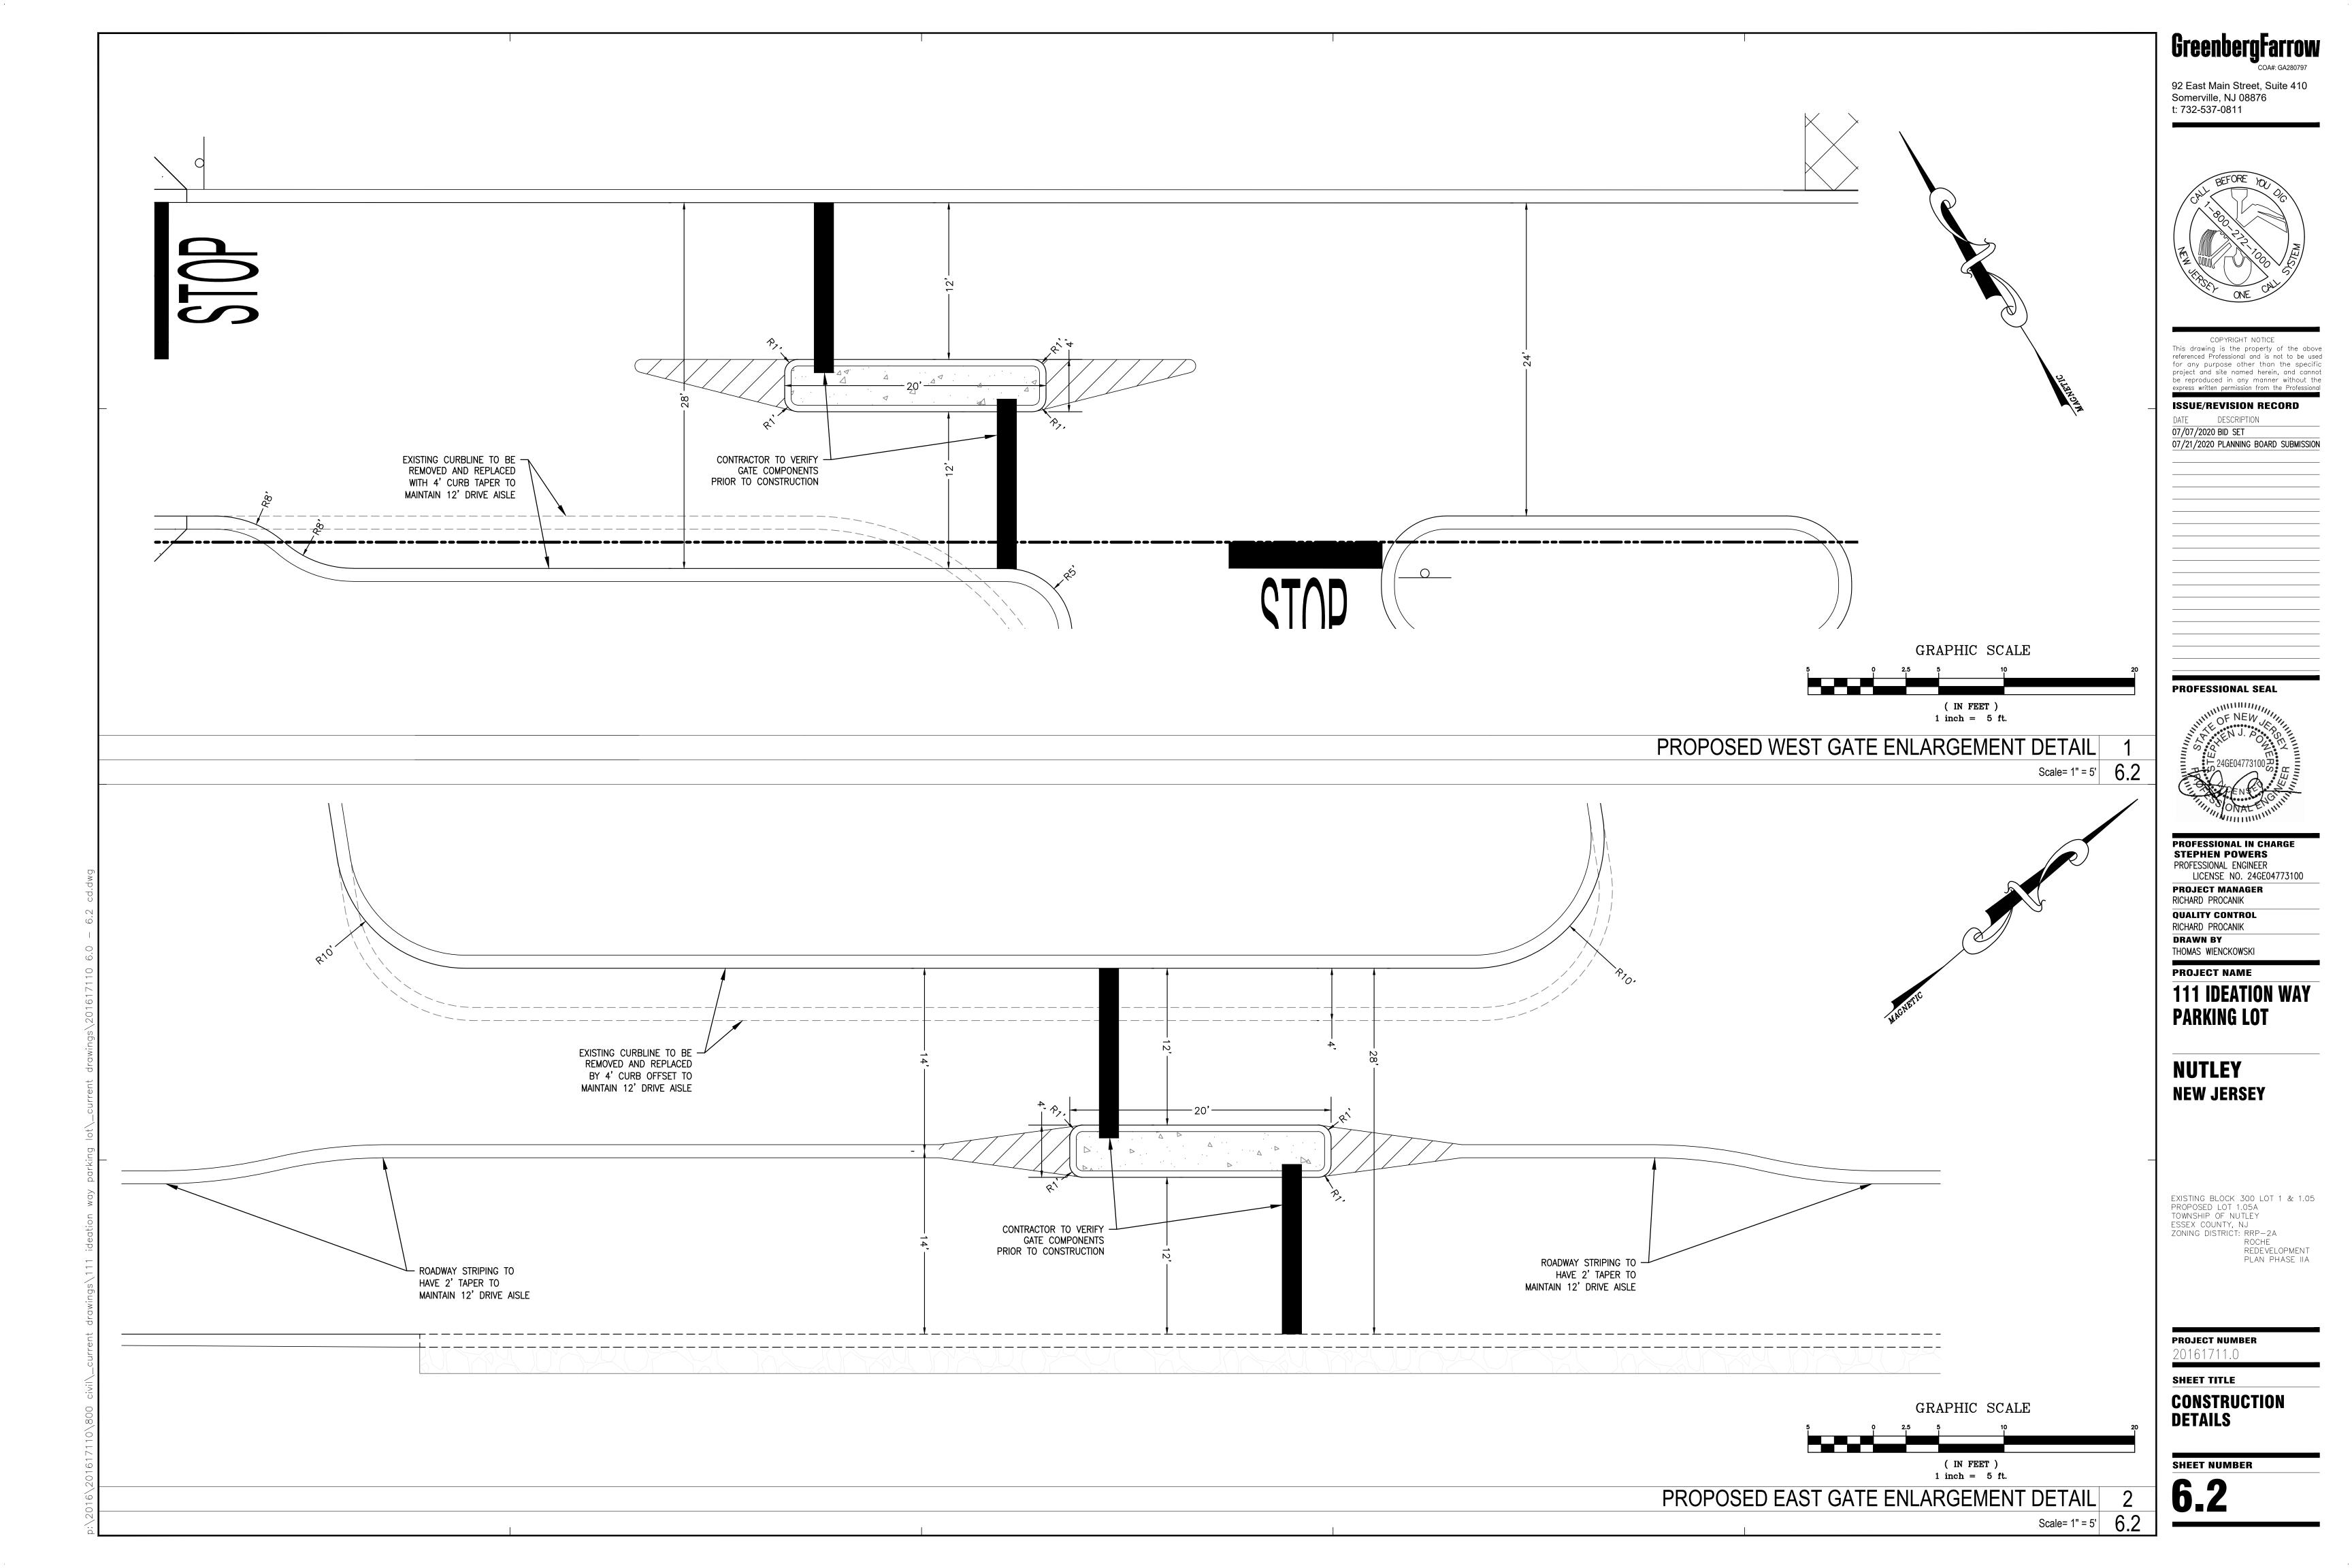

chedule					
Label	Catalog Number	Arrangement	LLF	Arr. Watts	Description
MPTC	MPTC-55W32LED3K-G2-LE4	SINGLE	1.000	55.9	Pole mounted @ 16'
AR	AR3E35-6013K	SINGLE	1.000	65	Pole mounted @ 16'
AR	AR3P70-8013K	SINGLE	1.000	186.3	Pole mounted @ 25'


lation Summary							
	CalcType	Units	Avg	Max	Min	Avg/Min	Max/Min
deation Way	Illuminance	Fc	2.22	6.4	0.5	4.44	12.80
LCULATION SUMMARY IS BA	SED ON FOOTCANDLE	S WITHIN T	HE PARKI	ING LOT	AREAS	ONLY.	

PROPERTY LINE

GENERAL LIGHTING NOTES

REFER TO SHEET 6.0/DETAIL 10 FOR LIGHTING POLE BASE DETAILS.
 SITE LIGHTING SHALL BE TURNED OFF AFTER 11 PM.

9) LIGHT POLES TO REMAIN IN PLACE 5) LIGHT POLES TO BE RELOCATED (4) LIGHT POLES TO BE ADDED (1) LIGHT FIXTURE TO BE ROTATED

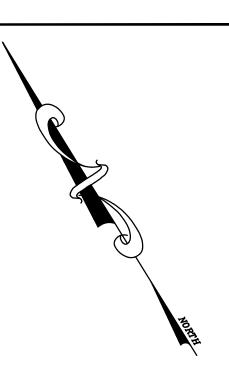

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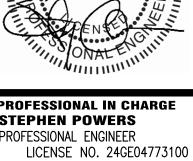
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ISSUE/REVISION RECORD DATE DESCRIPTION 07/07/2020 BID SET 07/21/2020 PLANNING BOARD SUBMISSION **PROFESSIONAL SEAL PROFESSIONAL IN CHARGE**







QUALITY CONTROL RICHARD PROCANIK DRAWN BY THOMAS WIENCKOWSKI PROJECT NAME **111 IDEATION WAY**

PARKING LOT





EXISTING BLOCK 300 LOT 1 & 1.05 PROPOSED LOT 1.05A TOWNSHIP OF NUTLEY

ROCHE REDEVELOPMENT PLAN PHASE IIA

ESSEX COUNTY, NJ ZONING DISTRICT: RRP-2A

PROJECT NUMBER

20161711.0

SHEET TITLE

LIGHTING

SHEET NUMBER

PLAN

7.0

NEW JERSEY

NUTLEY




GRAPHIC SCALE

(IN FEET)

1 inch = 30 ft.



2016\201617110\800 civi_current drawings\111 ideation way parking lot_current drawings\201617110 8.0 autoturn.dwg

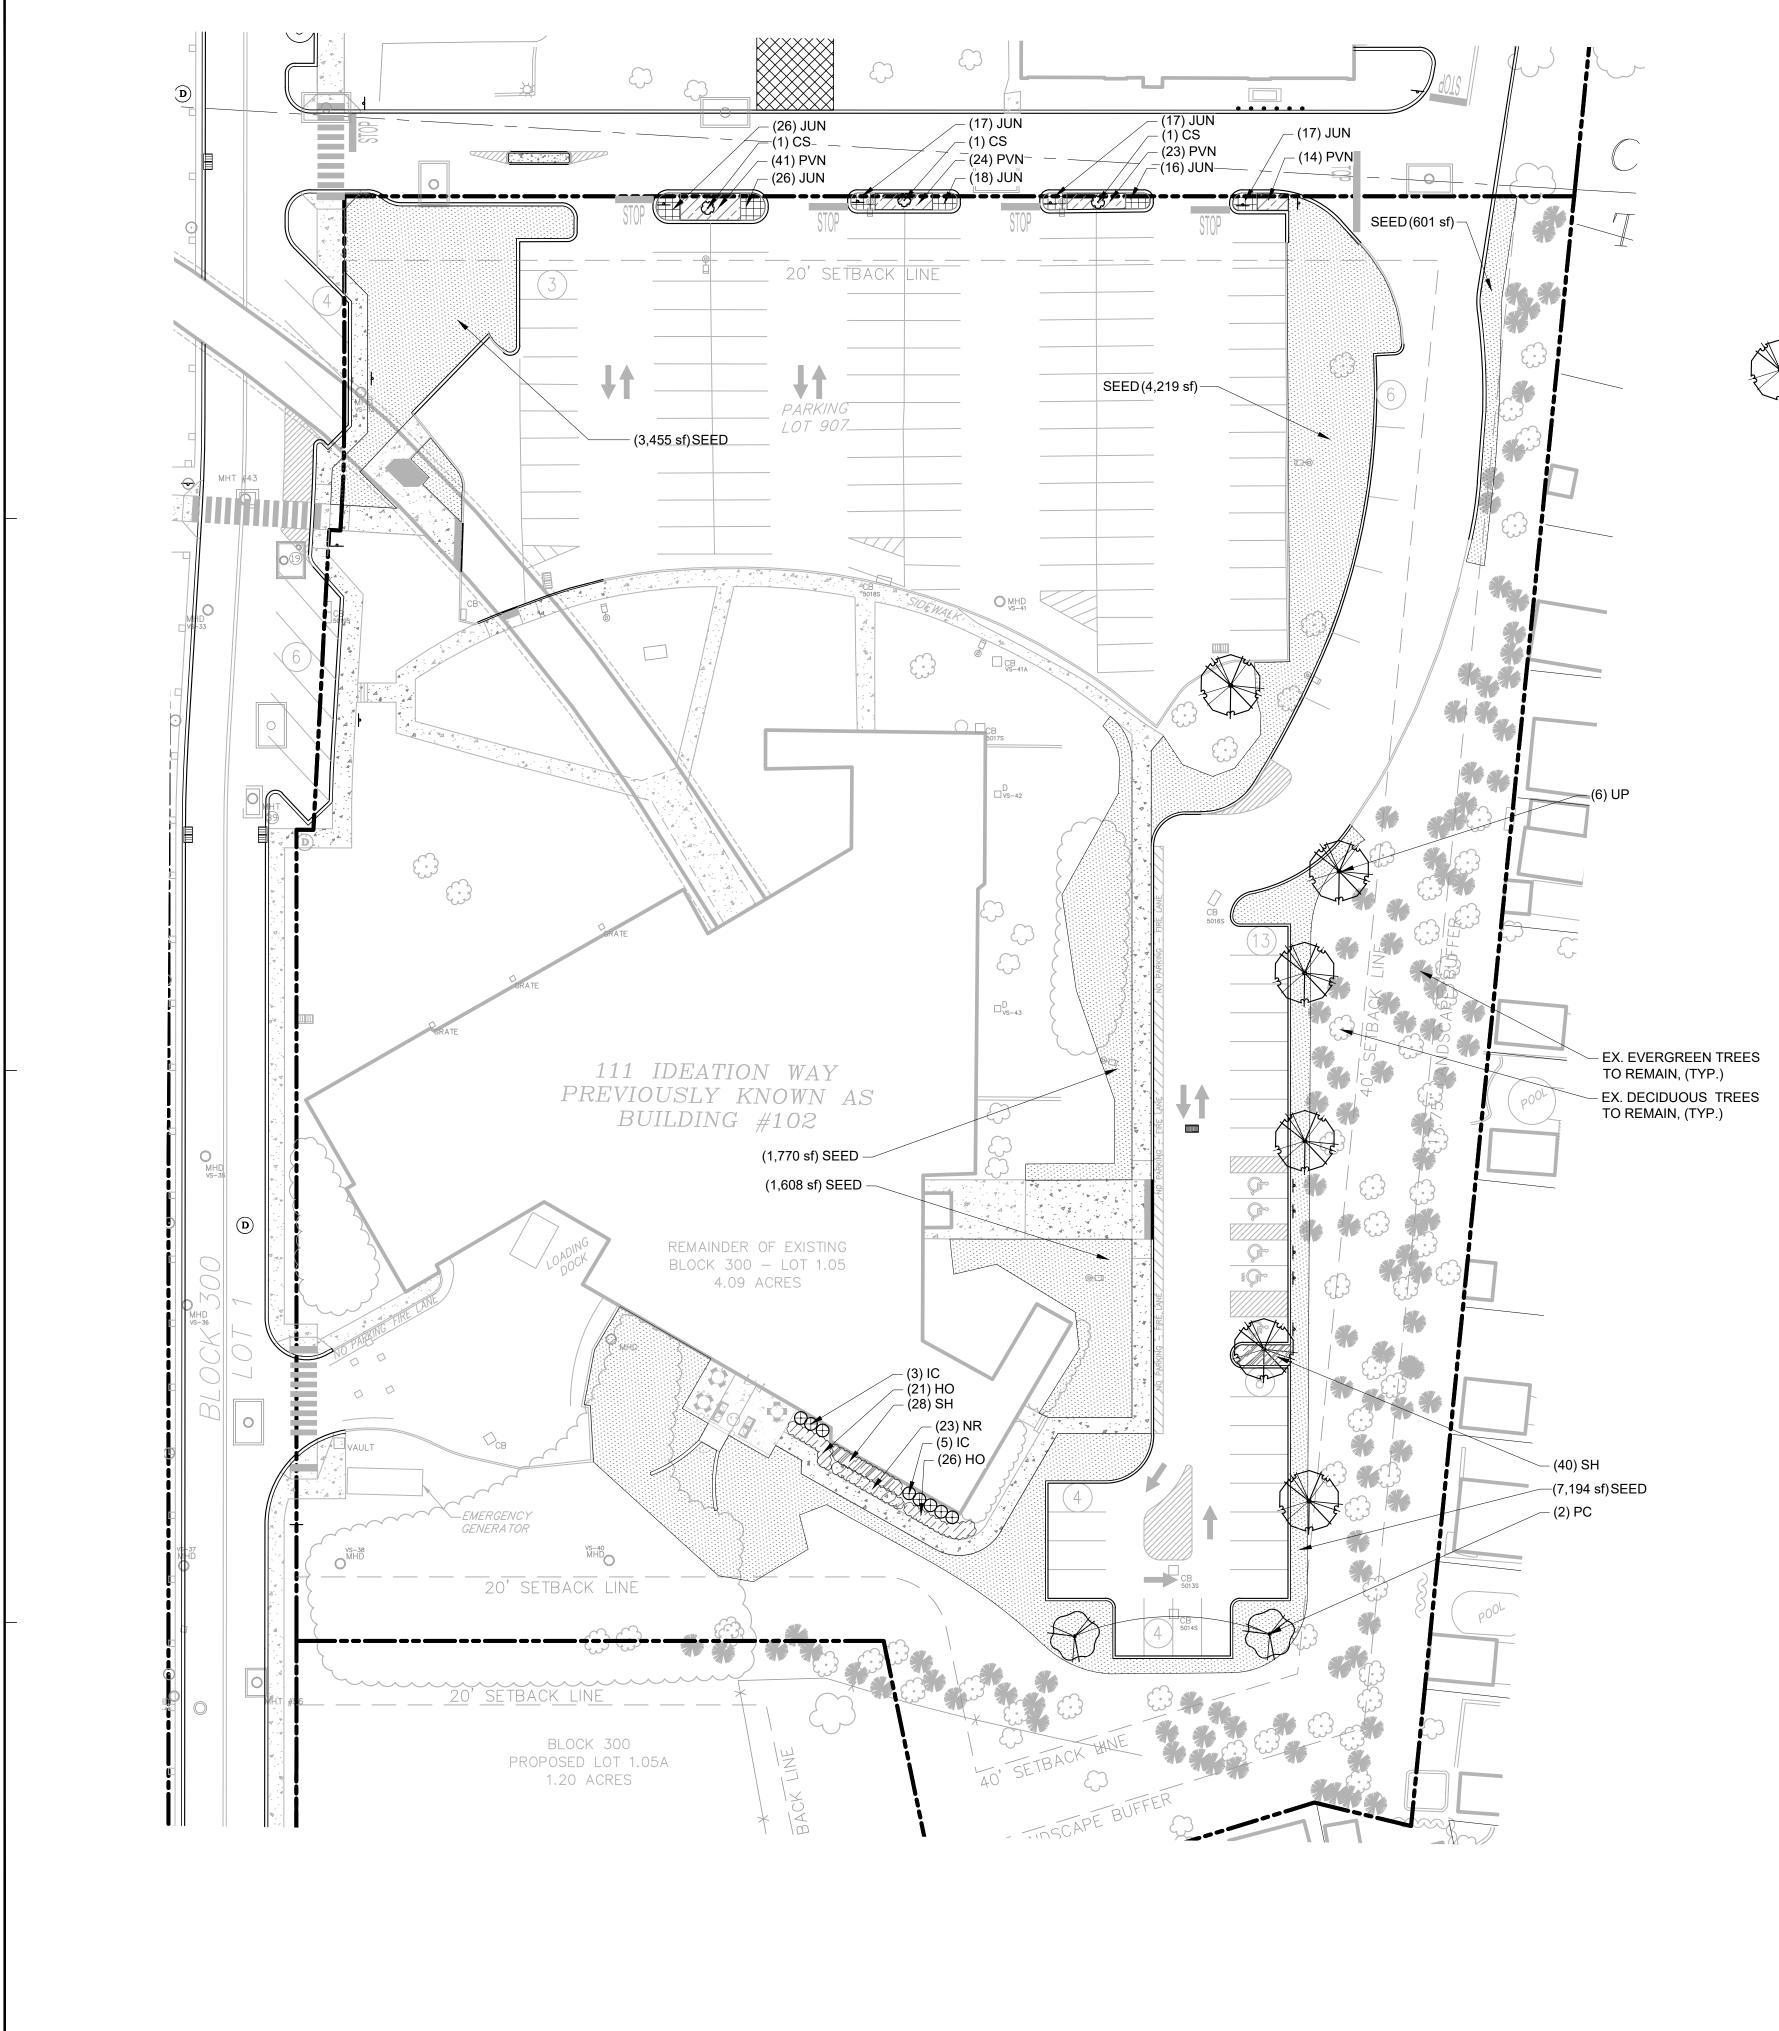

LANDSCAPE CALCULATIONS:

	PARKING LOT INTERI	OR LAND	SCAPE	REQUIRED: 5%	PROVIDED: 13%		-		
	AREA)				(6,563 SF INTERIOR LANDSCA	APE AREA / 51,159 SF PARKIN	G		
	1 TREE PER 5 PARKIN	NG SPAC	ES	8 TREES (38 NEW SPACES / 5 = 7.6)	8 TREES				
	PLANT SC	HED	ULE	,					
	TREES	CODE	QTY	BOTANICAL NAME		COMMON NAME	CONT	CAL	SIZE
et -	The second secon	PC	2	PYRUS CALLERYANA `	GLEN`S FORM` TM	CHANTICLEER PEAR	B & B	3"CAL	10` MIN.
	F	UP	6	ULMUS AMERICANA `P	RINCETON	AMERICAN ELM	B & B	3"CAL	
	SHRUBS		QTY	BOTANICAL NAME		COMMON NAME	CONT	HEIGHT	
	\oplus	IC	8	ILEX GLABRA `COMPAG	CTA`	COMPACT INKBERRY HOLLY	#03/3 GAL		
	DECIDUOUS	CODE	QTY	BOTANICAL NAME		COMMON NAME	CONT	HEIGHT	
	\bigcirc	CS	3	CORNUS ALBA `SIBIRIO FULL WELL ROOTED	CA`	REDBARK DOGWOOD	B & B		
	SHRUB AREAS	CODE	QTY	BOTANICAL NAME		COMMON NAME	CONT		
		JUN	137	JUNIPERUS HORIZONT	FALIS `WILTONII`	BLUE RUG JUNIPER	3 GAL		
	GROUND COVERS	CODE	QTY	BOTANICAL NAME		COMMON NAME	CONT		
		HO	47	HEMEROCALLIS X `STE	ELLA DE ORO`	STELLA DE ORO DAYLILY	1 GAL@ 24" O.C.		
		SEED	18,847 SF	KENTUCKY BLUE GRAS REFER TO SOIL EROSI	SS AND TURF-TYPE TALL FESCUE ON PLANS	SEED MIX	SEED		
		NR	23	NEPETA RACEMOSA `V	WALKER`S LOW`	CATMINT	1 GAL@ 24" O.C.		
		PVN	102	PANICUM VIRGATUM `I FULL WELL ROOTED IN		SWITCH GRASS	3 GAL		
		SH	68	SARCOCOCCA HOOKE FULL WELL ROOTED IN		SWEET BOX	3 GAL		


TREE CALIPER MEASUREMENTS ARE TO BE MEASURED AT A PLANTED HEIGHT OF 4.5 FEET. SHRUB HEIGHT MEASUREMENTS ARE TO BE AS MEASURED FROM TOP OF ROOTBALL (TYP.).

MAINTENANCE OF LANDSCAPING:

THE OWNER, TENANT, OR AGENT, IF ANY, SHALL BE RESPONSIBLE FOR PROVIDING, PROTECTING AND MAINTAINING ALL LANDSCAPING IN HEALTHY GROWING CONDITIONS, REPLACING IT WHEN NECESSARY TO ENSURE CONTINUOUS CONFORMANCE WITH THESE GUIDELINES AND KEEPING IT FREE FROM REFUSE AND DEBRIS. MAINTENANCE SHALL INCLUDE THE REPLACEMENT OF ALL DEAD PLANT MATERIAL WITHIN THE GUARANTEED CONTRACT PERIOD OF TWO (2) YEARS.

GENERAL NOTES:

- 1. GRAPHIC SYMBOLS TAKE PRECEDENCE OVER WRITTEN QUANTITIES AND KEYS ON PLAN.
- 2. CONTRACTOR TO REPAIR AND REPLACE ANY PLANT MATERIAL DAMAGED BY THIS CONSTRUCTION OUTSIDE PROJECT LIMITS. ANY EXISTING PLANT MATERIAL DAMAGED BY CONTRACTOR DURING CONSTRUCTION SHALL BE REPLACED WITH LIKE MATERIAL OF SIMILAR SPECIES AND SIZE AT THE CONTRACTOR'S EXPENSE WITH NO ADDITIONAL COST TO OWNER OR TENANT.
- 3. TWO WEEKS PRIOR TO PLANTING, THE CONTRACTOR SHALL SUBMIT TO THE OWNER / OWNER'S REPRESENTATIVE A PLANT PHOTO SUBMITTAL FOR APPROVAL. IF REQUESTED, BY THE OWNER, THE LANDSCAPE ARCHITECT WILL TAG THE MATERIAL.
- 4. EACH PHOTO SHALL CLEARLY SHOW THE SIZE, FORM, AND BRANCHING STRUCTURE AND QUALITY OF THE PLANT.
- 5. EACH PHOTO SHALL HAVE THE PLANT NAME, SIZE AND SPECIFICATIONS LABELED ON THE PHOTO.
- 6. ANY PHOTO SHOWING A GROUP OF PLANTS CLOSE TOGETHER WILL NOT BE ACCEPTED.
- 7. NO PARTIAL OR INCOMPLETE SUBMITTAL WILL BE ACCEPTED FOR REVIEW. ANY REJECTED SPECIES WILL BE SUBJECT TO RESUBMITTAL.
- 8. REFER TO THE LATEST CIVIL PLANS FOR DISTURBED AREAS TO BE RESTORED. ADDITIONAL RESTORATION MAY BE NEEDED DUE TO FIELD CONDITIONS. SEE CIVIL SITE PLAN.
- 9. TREE WATERING BAGS ARE RECOMMENDED FOR ALL PROPOSED TREES AT THE TIME OF INSTALLATION.

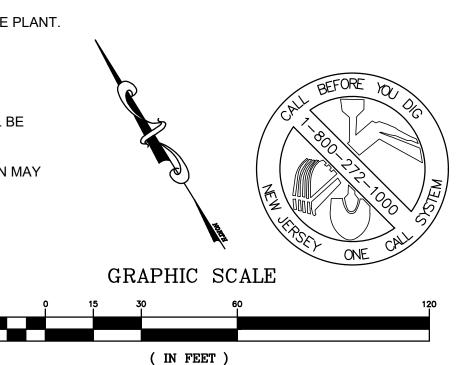

1 inch = 30 ft.

GreenbergFarrow OA#: COA# GA28079

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PROJECT TEAM

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PROJECT NAME
ON3 - 111 IDEATION WAY
PARKING LOT
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CAPITAL PARTNERS, LLC.

PROJECT NUMBER 20161711.0


SHEET TITLE

111 IDEATION WAY LANDSCAPE

PLAN

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NOTES:

LANDSCAPE PLANTING

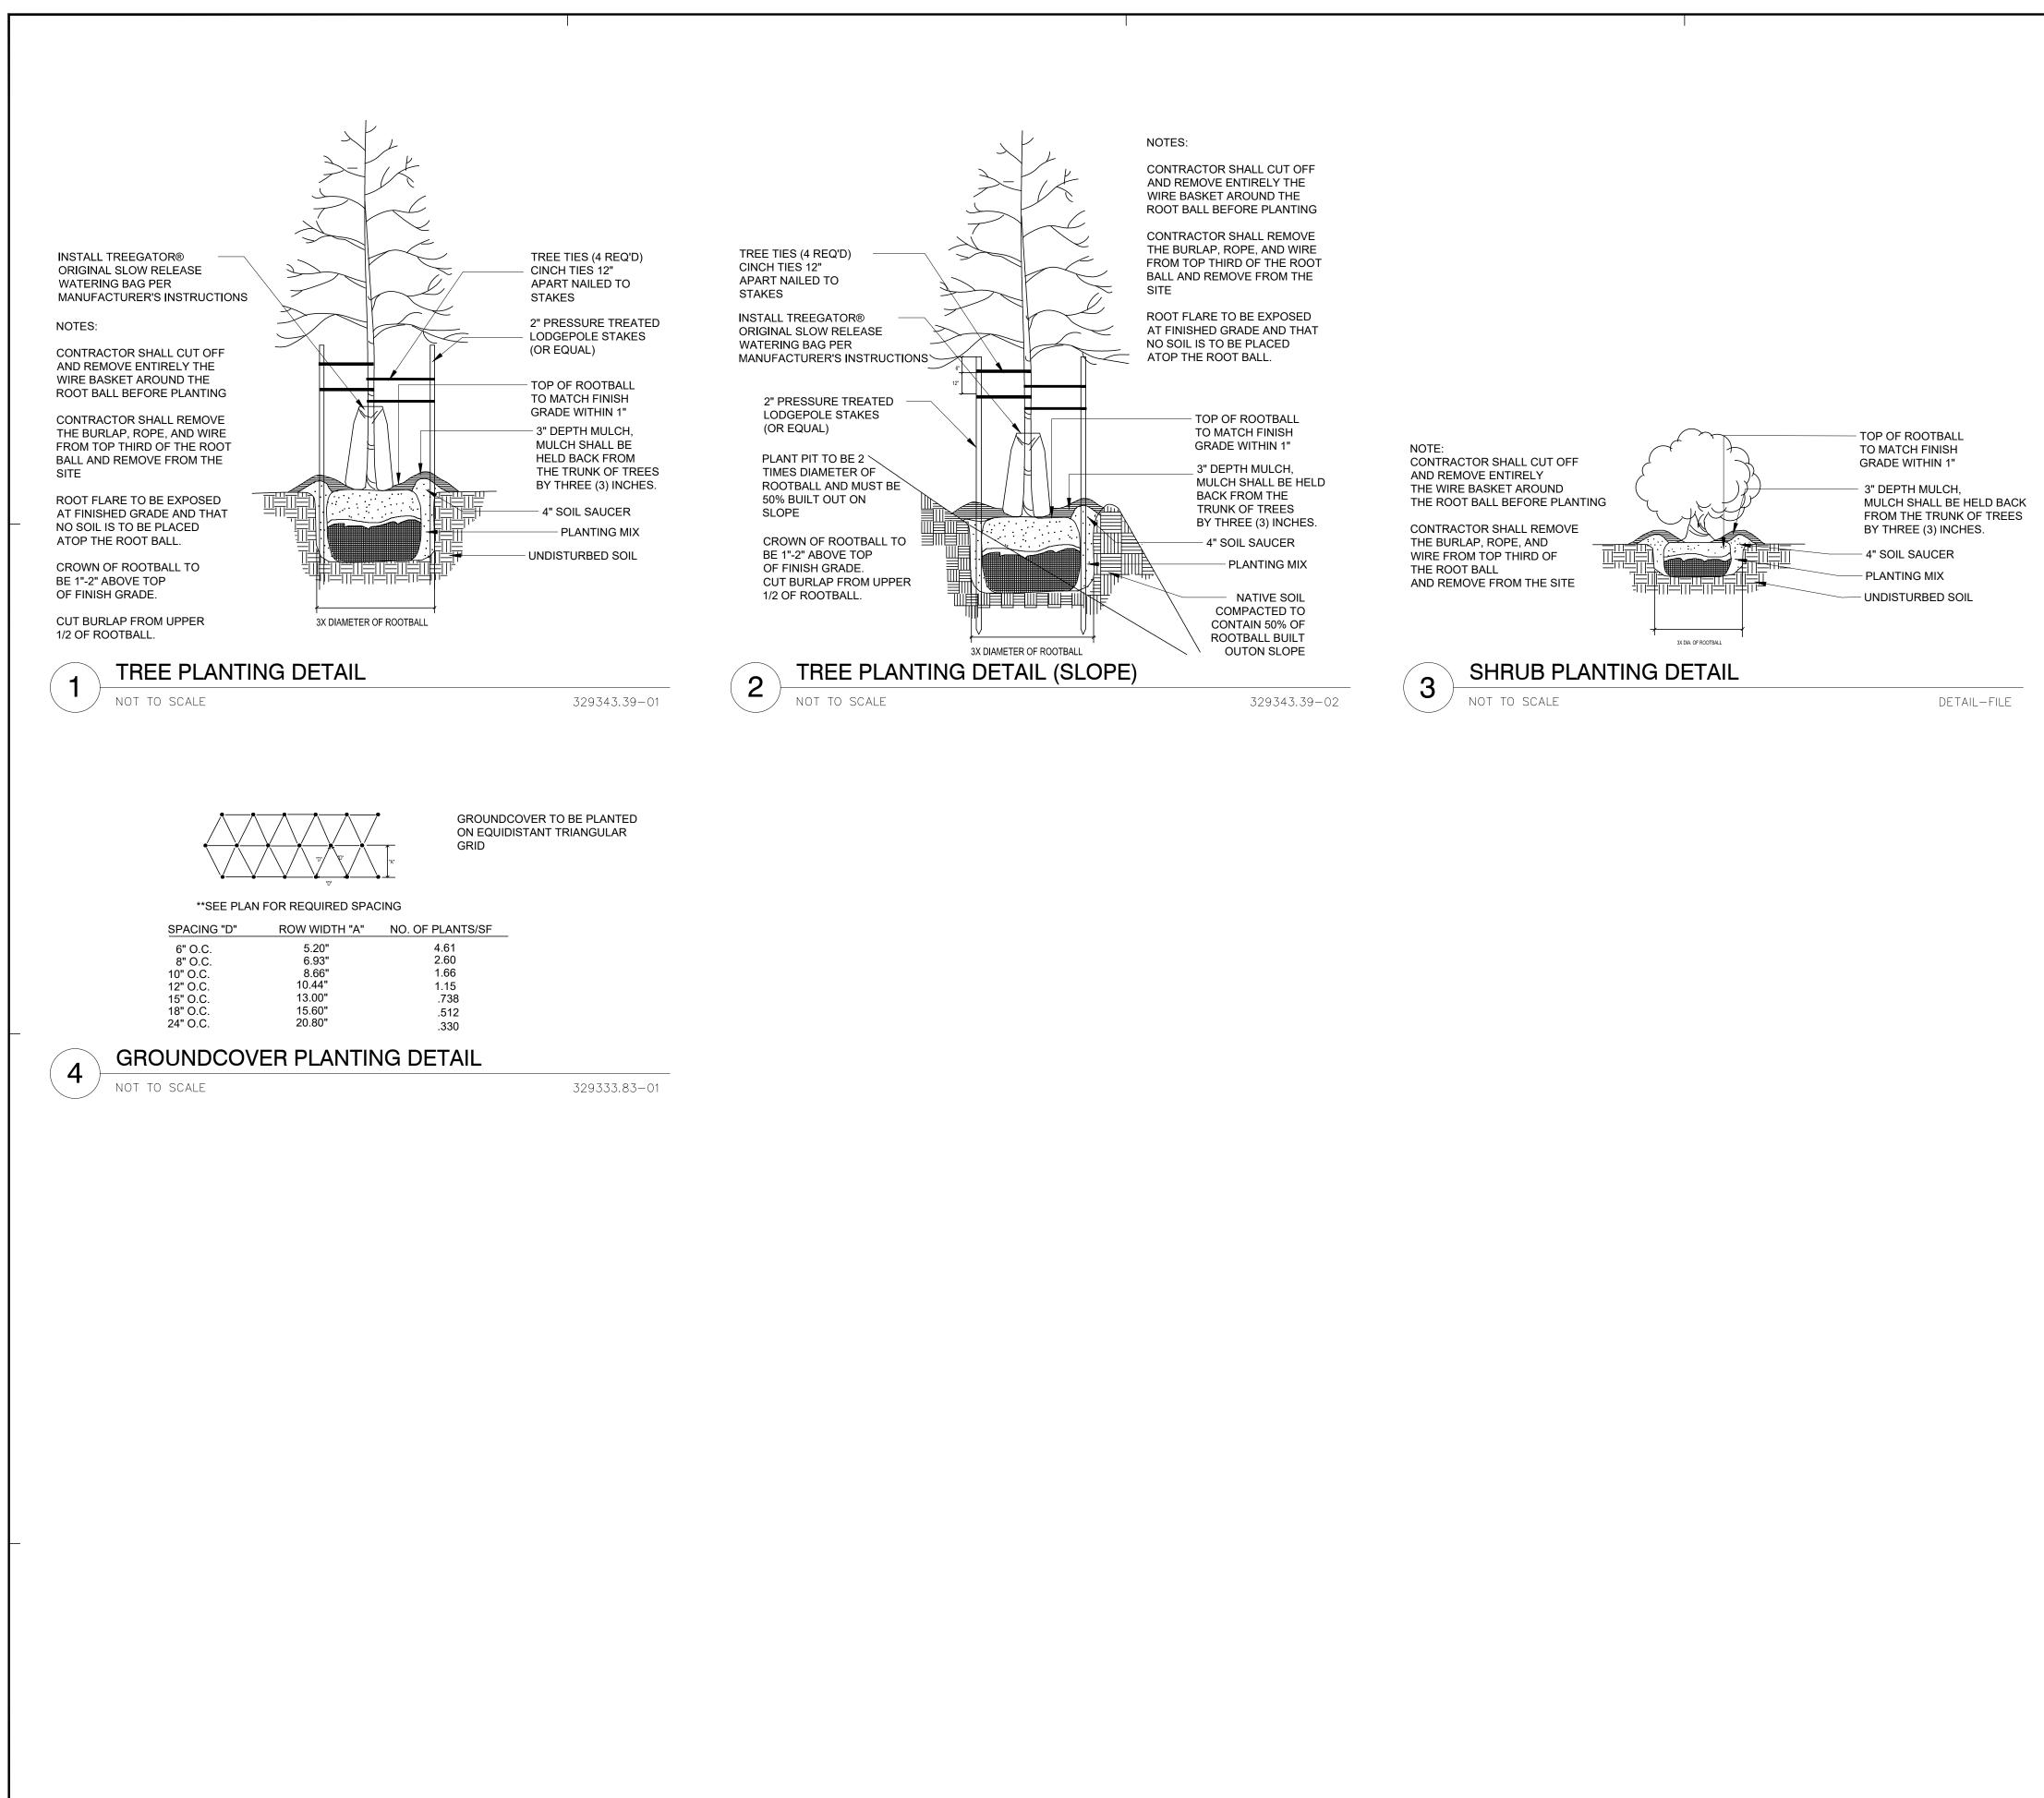- 1. THE LANDSCAPE CONTRACTOR SHALL FAMILIARIZE HIMSELF WITH THE SITE CONDITIONS AND VERIFY THEM TO HIS SATISFACTION. THE LANDSCAPE CONTRACTOR SHALL ACCEPT THE SITE CONDITIONS AND DO THE WORK SPECIFIED WITHOUT ADDITIONAL COMPENSATION FOR POSSIBLE VARIATION FROM GRADES AND CONDITIONS SHOWN.
- PRIOR TO CONSTRUCTION THE LANDSCAPE CONTRACTOR SHALL BE RESPONSIBLE FOR LOCATING ALL UNDERGROUND UTILITIES AND SHALL AVOID DAMAGE TO ALL UTILITIES DURING CONSTRUCTION. SHOULD THE LANDSCAPE CONTRACTOR CAUSE DAMAGE TO ANY UTILITIES HE SHALL MAKE NECESSARY REPAIRS AS QUICKLY AS POSSIBLE WITHOUT ADDITIONAL COMPENSATION.
- 3. ALL PLANT MATERIAL SIZES AND MEASUREMENTS, INCLUDING TRUNK, HEAD, AND SPREAD SIZES, CONTAINER AND ROOTBALL SIZES, QUALITY AND CONDITION SHALL CONFORM TO THE STANDARDS SET FORTH IN THE CURRENT ISSUE OF, "AMERICAN STANDARDS FOR NURSERY STOCK" (ANSI.Z60.1).
- 4. ALL PLANT MATERIAL ARE SUBJECT TO THE APPROVAL BY THE OWNER, AND MAY BE INSPECTED AT THE PLACE OF GROWTH OR ON SITE PRIOR TO PLANTING. LANDSCAPE ARCHITECT RETAINS THE RIGHT TO REJECT ANY PLANT MATERIAL WHICH IS NOT TO HIS SATISFACTION.
- THE LANDSCAPE CONTRACTOR SHALL BE RESPONSIBLE FOR MAINTAINING, IN FULL, ALL LANDSCAPE PLANTING WORK (INCLUDING WATERING, SPRAYING FOR INSECTS AND DISEASE, MULCHING, MOWING, FERTILIZING, CULTIVATING, EDGING AND WEEDING) FOR A PERIOD OF 90 DAYS AFTER ACCEPTANCE BY THE OWNER.
- THE LANDSCAPE CONTRACTOR SHALL COMPLETELY GUARANTEE ALL LANDSCAPE PLANTING WORK AND MATERIALS FOR A PERIOD OF ONE (1) FULL YEAR FROM THE DATE THE WORK HAS BEEN APPROVED BY THE OWNER AS INSTALLED. ALL PLANT MATERIAL NOT HEALTHY GROWING CONDITION SHALL BE REMOVED IMMEDIATELY AND REPLACED AS SOON AS POSSIBLE WITH LIKE KIND AND SIZE AT NO CHARGE TO THE OWNER.
- THE LANDSCAPE CONTRACTOR SHALL BE RESPONSIBLE FOR OBTAINING SOIL SAMPLES 7. FROM SOIL AND NATIVE OR FILL SOILS AT THE SITE AND SUBMITTING THEM TO AN APPROVED SOIL TESTING LABORATORY, AND OBTAIN ANALYSES AND RECOMMENDATIONS FOR AMENDING THESE SOILS AND FERTILIZATION OF SPECIFIED PLANT MATERIAL AT A MINIMUM ALL PLANTING AREAS SHALL BE FERTILIZED WITH 12 LBS. /1000 SF OF 10-10-10 FERTILIZER.
- 8. ALL PLANTING AREAS, SHRUB BEDS AND TREES SHALL BE MULCHED WITH A MINIMUM COMPACTED DEPTH OF THREE (3) INCHES OF MULCH AS SPECIFIED. PRIOR TO MULCHING APPLY A PRE-EMERGENT HERBICIDE (APPROVED BY OWNER) AS RECOMMENDED BY THE MANUFACTURER, TO PREVENT RECURRING WEED AND GRASS GROWTH.
- 9. CONTRACTOR IS TO TAKE SPECIAL CARE WHEN INSTALLING NEW PLANT MATERIAL SO AS NOT TO DISTURB ANY EXISTING PLANTINGS DESIGNATED TO REMAIN. ANY EXISTING PLANT MATERIAL DAMAGED BY CONTRACTOR DURING CONSTRUCTION SHALL BE REPLACED WITH LIKE MATERIAL OF SIMILAR SPECIES AND SIZE AT THE CONTRACTOR'S EXPENSE AND NO ADDITIONAL COST TO OWNER.

TURF AND LAWNS

- 10. ALL DISTURBED AREAS SHALL RECEIVE 4" MINIMUM OF TOPSOIL (COMPACTED) AND GRASSED WITH SOD OR SEED AS INDICATED ON PLAN. LANDSCAPE CONTRACTOR TO COORDINATE HIS/HER WORK WITH OTHER TRADES REGARDING FINISH GRADING. IF AVAILABLE CONTRACTOR IS TO USE STOCKPILED TOPSOIL ONSITE. IF NOT AVAILABLE THE LANDSCAPE CONTRACTOR WILL BE RESPONSIBLE FOR IMPORTING THE TOPSOIL NECESSARY TO MEET FINISH GRADE.
- 11. TOPSOIL, SHALL BE FERTILE, FRIABLE AND REPRESENTATIVE OF LOCAL PRODUCTIVE SOIL, CAPABLE OF SUSTAINING VIGOROUS PLANT GROWTH AND FREE OF CLAY LUMPS, SUBSOIL, NOXIOUS WEEDS OR OTHER FOREIGN MATTER SUCH AS STONES, ROOTS, STICKS AND OTHER EXTRANEOUS MATERIALS: NOT FROZEN OR MUDDY. PH OF TOPSOIL TO RANGE BETWEEN 5.5 AND 7.5.
- 12. SODDED AREAS SHALL BE GRASSED WITH SPECIES PER THE PLANT SCHEDULE. SOD SHALL BE LAID WITH CLOSE, TIGHT FITTING JOINTS, WHICH SHALL BE LAID IN ROWS PARALLEL TO THE CONTOUR LINES. ALL SODDED AREAS SHALL BE ROLLED TO ACHIEVE A SMOOTH, UNIFORM LAWN.
- 13. SEEDED AREAS SHALL BE GRASSED WITH SPECIES PER THE PLANT SCHEDULE AT A RATE OF (5) POUNDS PER 1000 SQ. FT. OF GRASSED AREA. SEED MAY BE APPLIED EITHER BY A MECHANICAL SPREADER OR HYDROSEEDING. WHICHEVER METHOD IS CHOSEN A THICK STAND OF GRASS SHALL BE ACHIEVED WITHIN 21 DAYS OR A SECOND OVERSEEDING WILL BE REQUIRED.
- 14. FERTILIZATION AND SOIL AMENDMENTS FOR ALL GRASSED AREAS SHALL BE AS PER LABORATORY ANALYSIS. HYDROSEEDING MAY BE SUBSTITUTED FOR MECHANICAL SEEDING BY MIXING SEED, FERTILIZER AND PULVERIZED MULCH IN WATER, USING EQUIPMENT SPECIFICALLY DESIGNED FOR HYDROSEED APPLICATION. MIX UNTIL UNIFORMLY BLENDED INTO HOMOGENEOUS SLURRY SUITABLE FOR HYDRAULIC APPLICATION. APPLY UNIFORMLY AT A RATE AS REQUIRED TO OBTAIN SPECIFIED SEEDING RATE.
- 15. ANY EXISTING LAWN AREA DISTURBED BY CONSTRUCTION IS TO BE REPAIRED TO ITS ORIGINAL CONDITION BY SEEDING AT NO ADDITIONAL COST TO THE OWNER.
- 16. REFER TO THE LATEST CIVIL PLANS FOR DISTURBED AREAS TO BE RESTORED. ADDITIONAL RESTORATION MAY BE NEEDED DUE TO FIELD CONDITIONS. SEE CIVIL SITE PLAN.

TREES AND SHRUBS

- 17. ALL TREES LOCATED IN GRASSED AREAS SHALL BE PLANTED AS PER DETAIL AND MULCHED WITH AT LEAST FOUR (4) FOOT DIAMETER OF SHREDDED BARK MULCH, TO A MINIMUM 3" DEPTH.
- 18. SHRUB BEDS SHALL BE MOUNDED WITH TOPSOIL A MINIMUM OF 6" ABOVE TOP OF CURB AND SHALL BE MULCHED WITH A 3" DEPTH OF SHREDDED BARK MULCH.
- 19. TREES SHALL BE PLANTED NO CLOSER THAN FIVE (5) FEET FROM BACK OF SIDEWALK OR BUILDING STRUCTURE.
- 20. LOCATION AND LAYOUT OF ALL SHRUBS AND TREES SHALL BE APPROVED BY LANDSCAPE ARCHITECT.
- 21. ALL TREE PROTECTION DEVICES ARE TO BE INSTALLED PRIOR TO START OF LAND DISTURBANCE AND MAINTAINED UNTIL FINAL LANDSCAPING IS INSTALLED.
- 22. ALL TREES ARE TO BE STAKED AND GUYED PER PLANTING DETAILS.

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PROJECT TEAM

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PROJECT NUMBER 20161711.0

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111 IDEATION WAY LANDSCAPE NOTES & DETAILS

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